

Advisory Design Panel Report For the Meeting of January 24, 2024

To: Advisory Design Panel Date: January 16, 2024

From: Kasha Janota-Bzowska, Planner

Development Permit with Variances Application No. 00249 for 1276/1278 Subject:

Gladstone Avenue

EXECUTIVE SUMMARY

The Advisory Design Panel (ADP) is requested to review a Development Permit with Variances Application for 1276/1278 Gladstone Avenue and provide advice to Council.

The subject property is designated Small Urban Village in the Official Community Plan (OCP, 2012), which supports low-rise multi-unit buildings, mixed use buildings, and freestanding commercial buildings generally up to four storeys in height. Density of up to a maximum of approximately 2:1 floor space ratio (FSR) is permitted for locations that support the growth management concept of the OCP and Fernwood Neighbourhood Plan (FNP, 2022) objectives.

The FNP is consistent with the OCP uses and density envisioned for the site. The proposed increases in height, massing, setbacks, and density in this location are all supported by the OCP and the FNP, as is the ground-oriented commercial with residential above the first-floor design.

The proposed development is generally consistent with the relevant design guidelines associated with Development Permit Area 6B (HC): Small Urban Village Heritage as they relate to inclusion of heritage, building orientation, relationship to the street, and amenities and livability for tenants.

Staff are looking for commentary from the ADP with regard to:

- building design elements
- · setbacks, height, and massing
- any other aspects of the proposal on which the ADP chooses to comment.

The Options section of this report provides guidance on possible recommendations that the Panel may make, or use as a basis to modify, in providing advice on this application.

BACKGROUND

Applicant: Mr. Tonny Kiptoo

Ms. Ashley Kiptoo

Architect: Mr. Colin Harper, Architect AIBC

CHA Architects

Development Permit Area: Development Permit Area 6B (HC) - Small Urban Villages

Heritage

Heritage Status: N/A

Description of Proposal

The proposal is for a 19-unit mixed use building consisting of 18 residential rental units and one commercial unit. The proposed new building presents itself as three storeys from the street view along Gladstone Avenue but is technically five storeys, as it has one storey below grade, one storey at ground level, two upper storeys and roof top addition for the upper storey units. It has been architecturally designed to take advantage of existing site topography and steep slope which allows it to have a storey below the ground floor, as well as a storey with ground level access. The proposed five-unit studio sized apartments with ground level access off Gladstone Avenue will be adaptable dwelling units designed for individuals with mobility challenges. Two units have private balconies, and the upper floor units have access via stairwells, which continue up to the roof top addition. The commercial unit is 132.26 m² in size, and proposed density is 1.52:1 FSR.

An associated rezoning application would increase the density from 0.30:1 FSR to 1:52:1 FSR and allow for multiple dwelling units and a ground floor commercial unit as permitted uses on site.

The proposed variances are related to setbacks, height, and parking.

Major design components include:

- 18 residential rental units with a range of unit sizes from studio to three bedroom
- five studio sized adaptable dwelling units with ground floor access
- one commercial unit fronting onto Gladstone Avenue
- private outdoor space for eight of the 18 units
- · zero parking spaces proposed.

Exterior finishes include:

- reclaimed brick
- vertical stack bond brick
- black fibre cement board & batten siding
- clear seal architectural concrete
- black brake metal flashing
- yellow cedar T&G siding
- opaque privacy screen
- grey accent pavers
- · cedar fencing.

Landscaping elements include:

- four proposed vine maple trees in tree grates
- mix of permeable pavers and timber decking benches

- hick's yew hedge along exposed concrete wall for screening at the rear
- tall Oregon grape, Herbert evergreen azalea and deer fern shrubs in planter beds.

The following data table compares the proposal with the CR-F, Fernwood Commercial Residential District and CR-6, Commercial Residential Fernwood Village District zones, which have permitted mixed-use development projects in the identified Fernwood Village heritage conservation area.

An asterisk is used to identify where the current proposal does not meet the requirements of one or both of these zones.

Zoning Criteria	Proposal	CR-F Zone	CR-6 Zone	
Site area (m²) – minimum	626.40	N/A	N/A	
Density (Floor Space Ratio) – maximum	1.52:1*	1.40:1	1.00:1	
Lot width (m) – maximum	13.70	N/A	N/A	
Total floor area (m²) – maximum	949.46	N/A	N/A	
Height (m) – maximum	13.57*	12.00	10.60	
Storeys – maximum	5 storeys (4 storeys and a roof deck)	N/A	N/A	
Site coverage (%) – maximum	60.98 %	59.00 %	63.00 %	
Roof deck	Yes	Permitted	Permitted	
Setbacks (m) – Front	5.69*	6.00	3.50	
Setbacks (m) – Rear	3.95* – main face of building 1.00* – 1st storey and patio	6.00	7.50	
Setbacks (m) – Side (East)	2.09* – main face of building 1.44* – balconies 0.06* – steps	3.39	0.00	
Setbacks (m) – Side (West)	2.08* – main face of building 0.00* – 1st storey and patio 1.36* – balconies	3.39	1.50	
Vehicle parking – minimum	0*	18 - Residential	18 - Residential	
Visitor Vehicle Stalls (included in overall total)	0*	2 - Visitor	2 - Visitor	
Accessible Vehicle Stalls (included in overall total)	0*	1 - Accessible 1 - Van Accessible 0 - Visitor Accessible 0 - Van Visitor Accessible	1 - Accessible 1 - Van Accessible 0 - Visitor Accessible 0 - Van Visitor Accessible	

Zoning Criteria	Proposal	CR-F Zone	CR-6 Zone
Long Term Bicycle Parking	20.00	20.00	20.00
Short Term Bicycle Parking	7.00	7.00	7.00

Sustainability Features

The applicants Letter to Mayor and Council identified the following sustainability features:

use of recycled brick material.

Consistency with Policies and Design Guidelines

Official Community Plan, 2012

The Official Community Plan (OCP, 2012) designates the subject property as Small Urban Village, which envisions low-rise multi-unit, mixed use, and freestanding commercial buildings with heights generally ranging from two to four storeys depending on the existing and envisioned context of the area. Taller buildings are generally envisioned to be located in mixed-use forms.

Envisioned uses include residential and mixed use, commercial, home occupations, and live/work units. Low to medium density residential, mixed use, and freestanding commercial is encouraged with a base density of 1.5:1 FSR. Additional density of up to 2:1 FSR may be considered where public benefit is provided consistent with neighbourhood plan objectives.

The OCP also identifies the site as being within Development Permit Area 6B (HC) – Small Urban Villages Heritage.

Fernwood Neighbourhood Plan, 2022

The Fernwood Neighbourhood Plan (FNP, 2022) is consistent with the OCP and designates the subject property as Small Urban Village and located in the identified Heritage Conservation Area.

Within Fernwood Village, the FNP encourages a mix of commercial and community services with low-rise apartment residential and mixed-use buildings at densities of approximately 1.5:1 to 2.0:1 FSR, with higher densities in this range considered where public benefits or affordable housing is provided. The identified Heritage Conservation Area is a tool used to protect, preserve, and enhance the heritage value or character of related properties with collective historical significance.

The FNP also designates the property as being in a "commercial-desired area" of the Fernwood Village, which calls for considering mixed-use development with publicly orientated, active ground floor uses that may include retail, community and public servicing spaces, or art spaces. Where the ground floor of a new building is not entirely occupied by a commercial space, the FNP encourages active residential-orientated uses in the remaining portion of the ground floor.

Housing objectives in the FNP support the creation of multi-family development with varied tenure options including rental housing in the urban villages. Provide diverse mobility options and opportunities for people to choose car-light lifestyles and advance the City's heritage objectives.

Design Guidelines for Development Permit Area 6B (HC): Small Urban Villages Heritage

The OCP identifies this property in Development Permit Area 6B (HC): Small Urban Villages Heritage. The objectives for this DPA that are relevant to this location include:

- (a) accommodating Victoria's anticipated residential growth and associated housing growth in Small Urban Villages, and support future commercial and community services.
- (b) revitalizing an area of commercial use through infill development.
- (c) conserving and enhancing the heritage value and characteristic of the area.
- (d) enhancing the area through infill with a high quality of architecture, landscape and urban design that responds to its heritage setting through sensitive and innovative interventions.

The special features, characteristic and special conditions that justify this designation include:

- (a) Small Urban Villages as nodes of commercial and community services that support adjacent land use areas with potential for revitalization through infill, building additions and heritage conservation. Small Urban Villages have capacity for mixed-use development with active commercial at the street level and multi-family (multi-unit) residential.
- (b) The Fernwood Village area of the city is a small commercial district with a majority of buildings that date back to the Victorian and Edwardian eras. Many of the buildings are listed on the City of Victoria Heritage Register, and some are protected heritage property.

The design guidelines that apply to this application are:

- Fernwood Village Design Guidelines (2022)
- Standards and Guidelines for the Conservation of Historic Places in Canada
- City of Victoria Heritage Program Sign & Awning Guidelines (1981)
- Guidelines for Fences, Gates, and Shutters (2010).

ANALYSIS

The following sections identify and provide a brief analysis of the areas where the Panel is requested to provide commentary for review and consideration by both Staff and Council.

The Panel's commentary on any other aspects of the proposal is also welcome.

Building Design Elements

The Fernwood Village Design Guidelines say to articulate façades, especially for larger buildings, into a series of intervals, using vertically proportioned windows and bays, to reflect and fit within the established streetscape pattern. New development should seek to include a distinct roof line in the building design, through such measures as a simplified or contemporary cornice or parapet. Lighting by incorporating pedestrian-scale lighting along the length of the building face is key, as is locating and screening proposed rooftop structures so they are not visible from the public realm. The guidelines also say to provide varied roof lines across different buildings to create visual interest along the street, and to generally align floor heights, mid-cornice lines, windowsills, and top edges with those adjacent heritage buildings, and discourages blank walls along open spaces.

Staff invite the ADP members to provide commentary, if any, on the proposed building design elements as it relates to preserving the character defining features of the Fernwood Village.

Setbacks, Height, and Massing

Setbacks

Variances are being requested to reduce the front, rear, and side yard setbacks.

Setback	Proposed	CR-F Zone	CR-6 Zone
Setbacks (m) – Front	5.69*	6.00	3.50
Setbacks (m) – Rear	3.95* – main face of building 1.00* – 1st storey and patio	6.00	7.50
Setbacks (m) – Side (East)	2.09* – main face of building 1.44* – balconies 0.06* – steps	3.39	0.00
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The Fernwood Village Design Guidelines say that in the area adjacent to the established Fernwood Village where new commercial and mixed-use development is envisioned, locate and setback new buildings to achieve a minimum 4 metres from the curb to the face of the building.

The design guidelines also advise incorporating small setbacks for portions of the façade at street level in order to accommodate sidewalk cafes, patios, and other outdoor seating areas.

Height and Massing

The building is proposed to be 13.57 m in height, which is higher than the comparable CR-F zone and CR-6 zone in the Fernwood Village area (12.0 m and 10.60 m).

The shadow study identifies minor overshadowing in the am during the summer solstice months, and the applicant has made exterior design changes to mitigate this impact, including:

- Removing the rooftop access stair closest to the rear yard and replacing it with an exterior stair at the fourth storey, resulting in a stepped massing and reduced shade impact
- Brick banding has been added to match the street-facing elevation, additional windows have been provided and the façade has been broken up by the exterior stairs
- The cladding on the west and east façades have been changed from black standing metal seam siding to a wood style board and batten, with variation in the spacing of the boards on each level to differentiate the storeys and further break up the facade.

The inclusion of one storey below grade and the proposed roof top addition makes the proposed new building technically 5 storeys, and the OCP and FNP call for generally 2 to 4 storeys in height.

The Fernwood Village Design Guidelines advise that when integrated, ensure new rooftop additions are designed sensitively to enable conservation of the entire historic building, to use a less dominating colour or lighter shade of colour, and that rooftop additions should be stepped back from the primary façade a minimum 4m to preserve views of the Belfry Theatre's spire.

Staff invite the ADP members to provide commentary, if any, on the setback reduction requests, increase in height, and proposed rooftop addition.

OPTIONS

The following are three potential options that the Panel may consider using or modifying in formulating a recommendation to Council:

Option One

That the Advisory Design Panel recommend to Council that Development Permit Application No. 00249 for 1276/1278 Gladstone Avenue be approved as presented.

Option Two

That the Advisory Design Panel recommend to Council that Development Permit Application No. 00249 for 1276/1278 Gladstone Avenue be approved with the following changes:

• as listed by the ADP.

Option Three


That the Advisory Design Panel recommend to Council that Development Permit Application No. 00249 for 1276/1278 Gladstone Avenue does not sufficiently meet the applicable design guidelines and polices and should be declined (and key areas that should be revised include:)

• as listed by the ADP, if there is further advice on how the application could be improved.

ATTACHMENTS


- Subject Map
- Aerial Map
- Plans date stamped December 13, 2023
- Applicant's letter dated December 13, 2023

cc: Colin Harper, Applicant and Architect

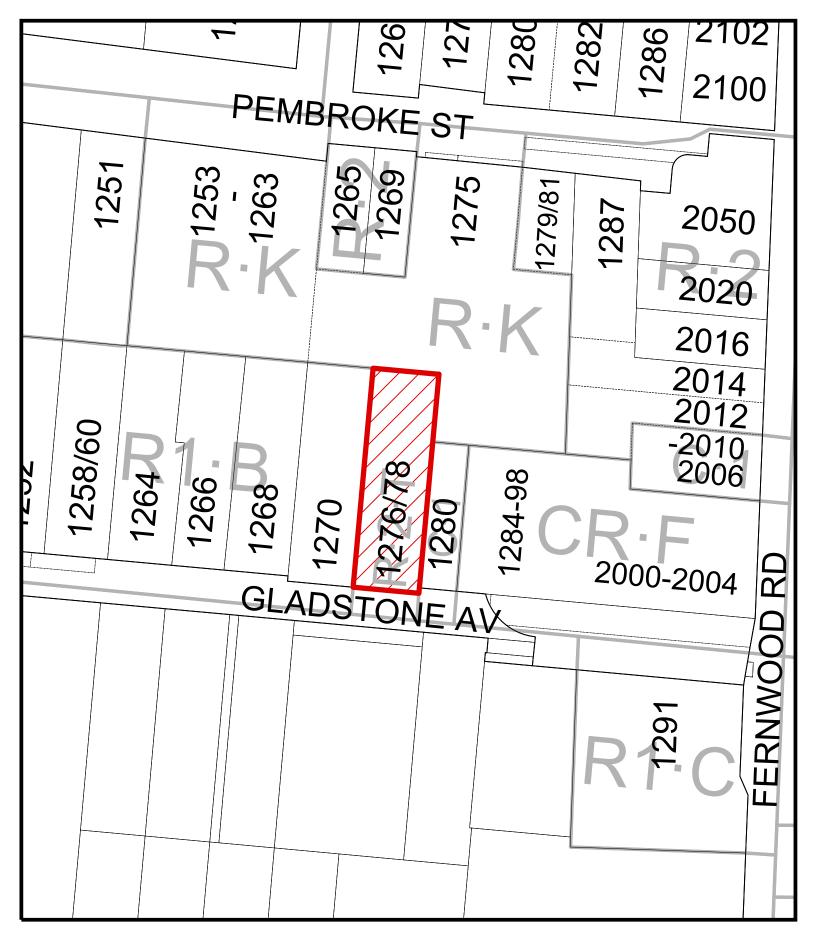





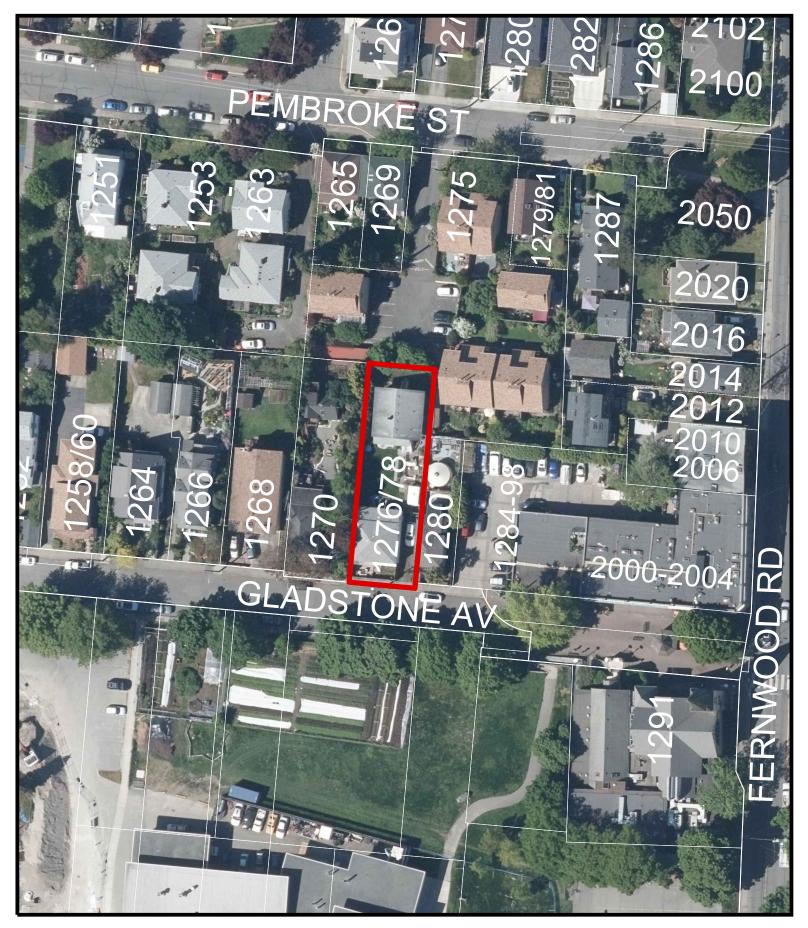





1276 GLADSTONE | 1276 GLADSTONE AVE.

PROJECT NUMBER: 2303

REISSUED FOR REZONING AND DEVELOPMENT PERMIT - DECEMBER 11, 2023

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DRAWING LIST

ARCHITECTURAL

A000	COVER
A001	CODE REVIEW
A002	AREA CALCULATIONS
A003	LIMITING DISTANCE
A005	SHADOW STUDY
A006	CONTEXT PLAN & STREETSCAPE

A007 SIGHTLINE DIAGRAM
A101 EXISTING SITE PLAN
A102 PROPOSED SITE PLAN
A202 LEVEL 1 FLOOR PLAN
A203 LEVEL 2 FLOOR PLAN
A204 LEVEL 3 FLOOR PLAN

A205 LEVEL 4 FLOOR PLAN
A206 ROOF PLAN
A301 ELEVATIONS
A302 ELEVATIONS
A303 MATERIAL BOARD


A304 RENDERINGS A401 SECTIONS

CIVIL

C1 CONCEPTUAL SITE SERVICING PLAN
C2 CONCEPTUAL GRADING PLAN

LANDSCAPE

L1	LANDSCAPE CONCEPT PLAN
L2	LANDSCAPE CONCEPT PLAN
L3	TREE MANAGEMENT PLAN

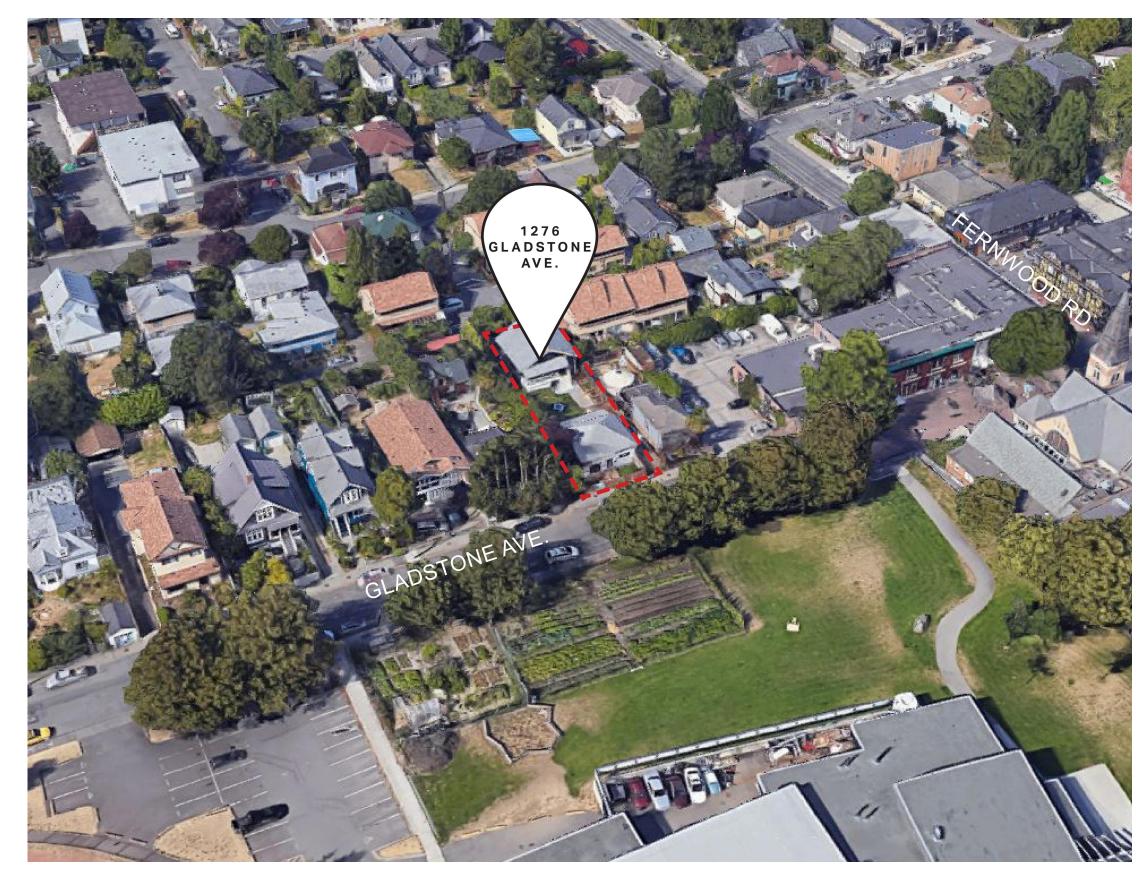





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NORTH ARROW

NOTES

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03 REISSUED FOR REZONING AND DEVELOPMENT PERMIT 12/11/20
02 ISSUED FOR REZONING AND DEVELOPMENT PERMIT 11/03/20
01 ISSUED FOR REZONING AND DEVELOPMENT PERMIT 09/15/20
NO. REVISION M/D/N

1276 GLADSTONE VICTORIA, BC

PROJECT ADDRESS


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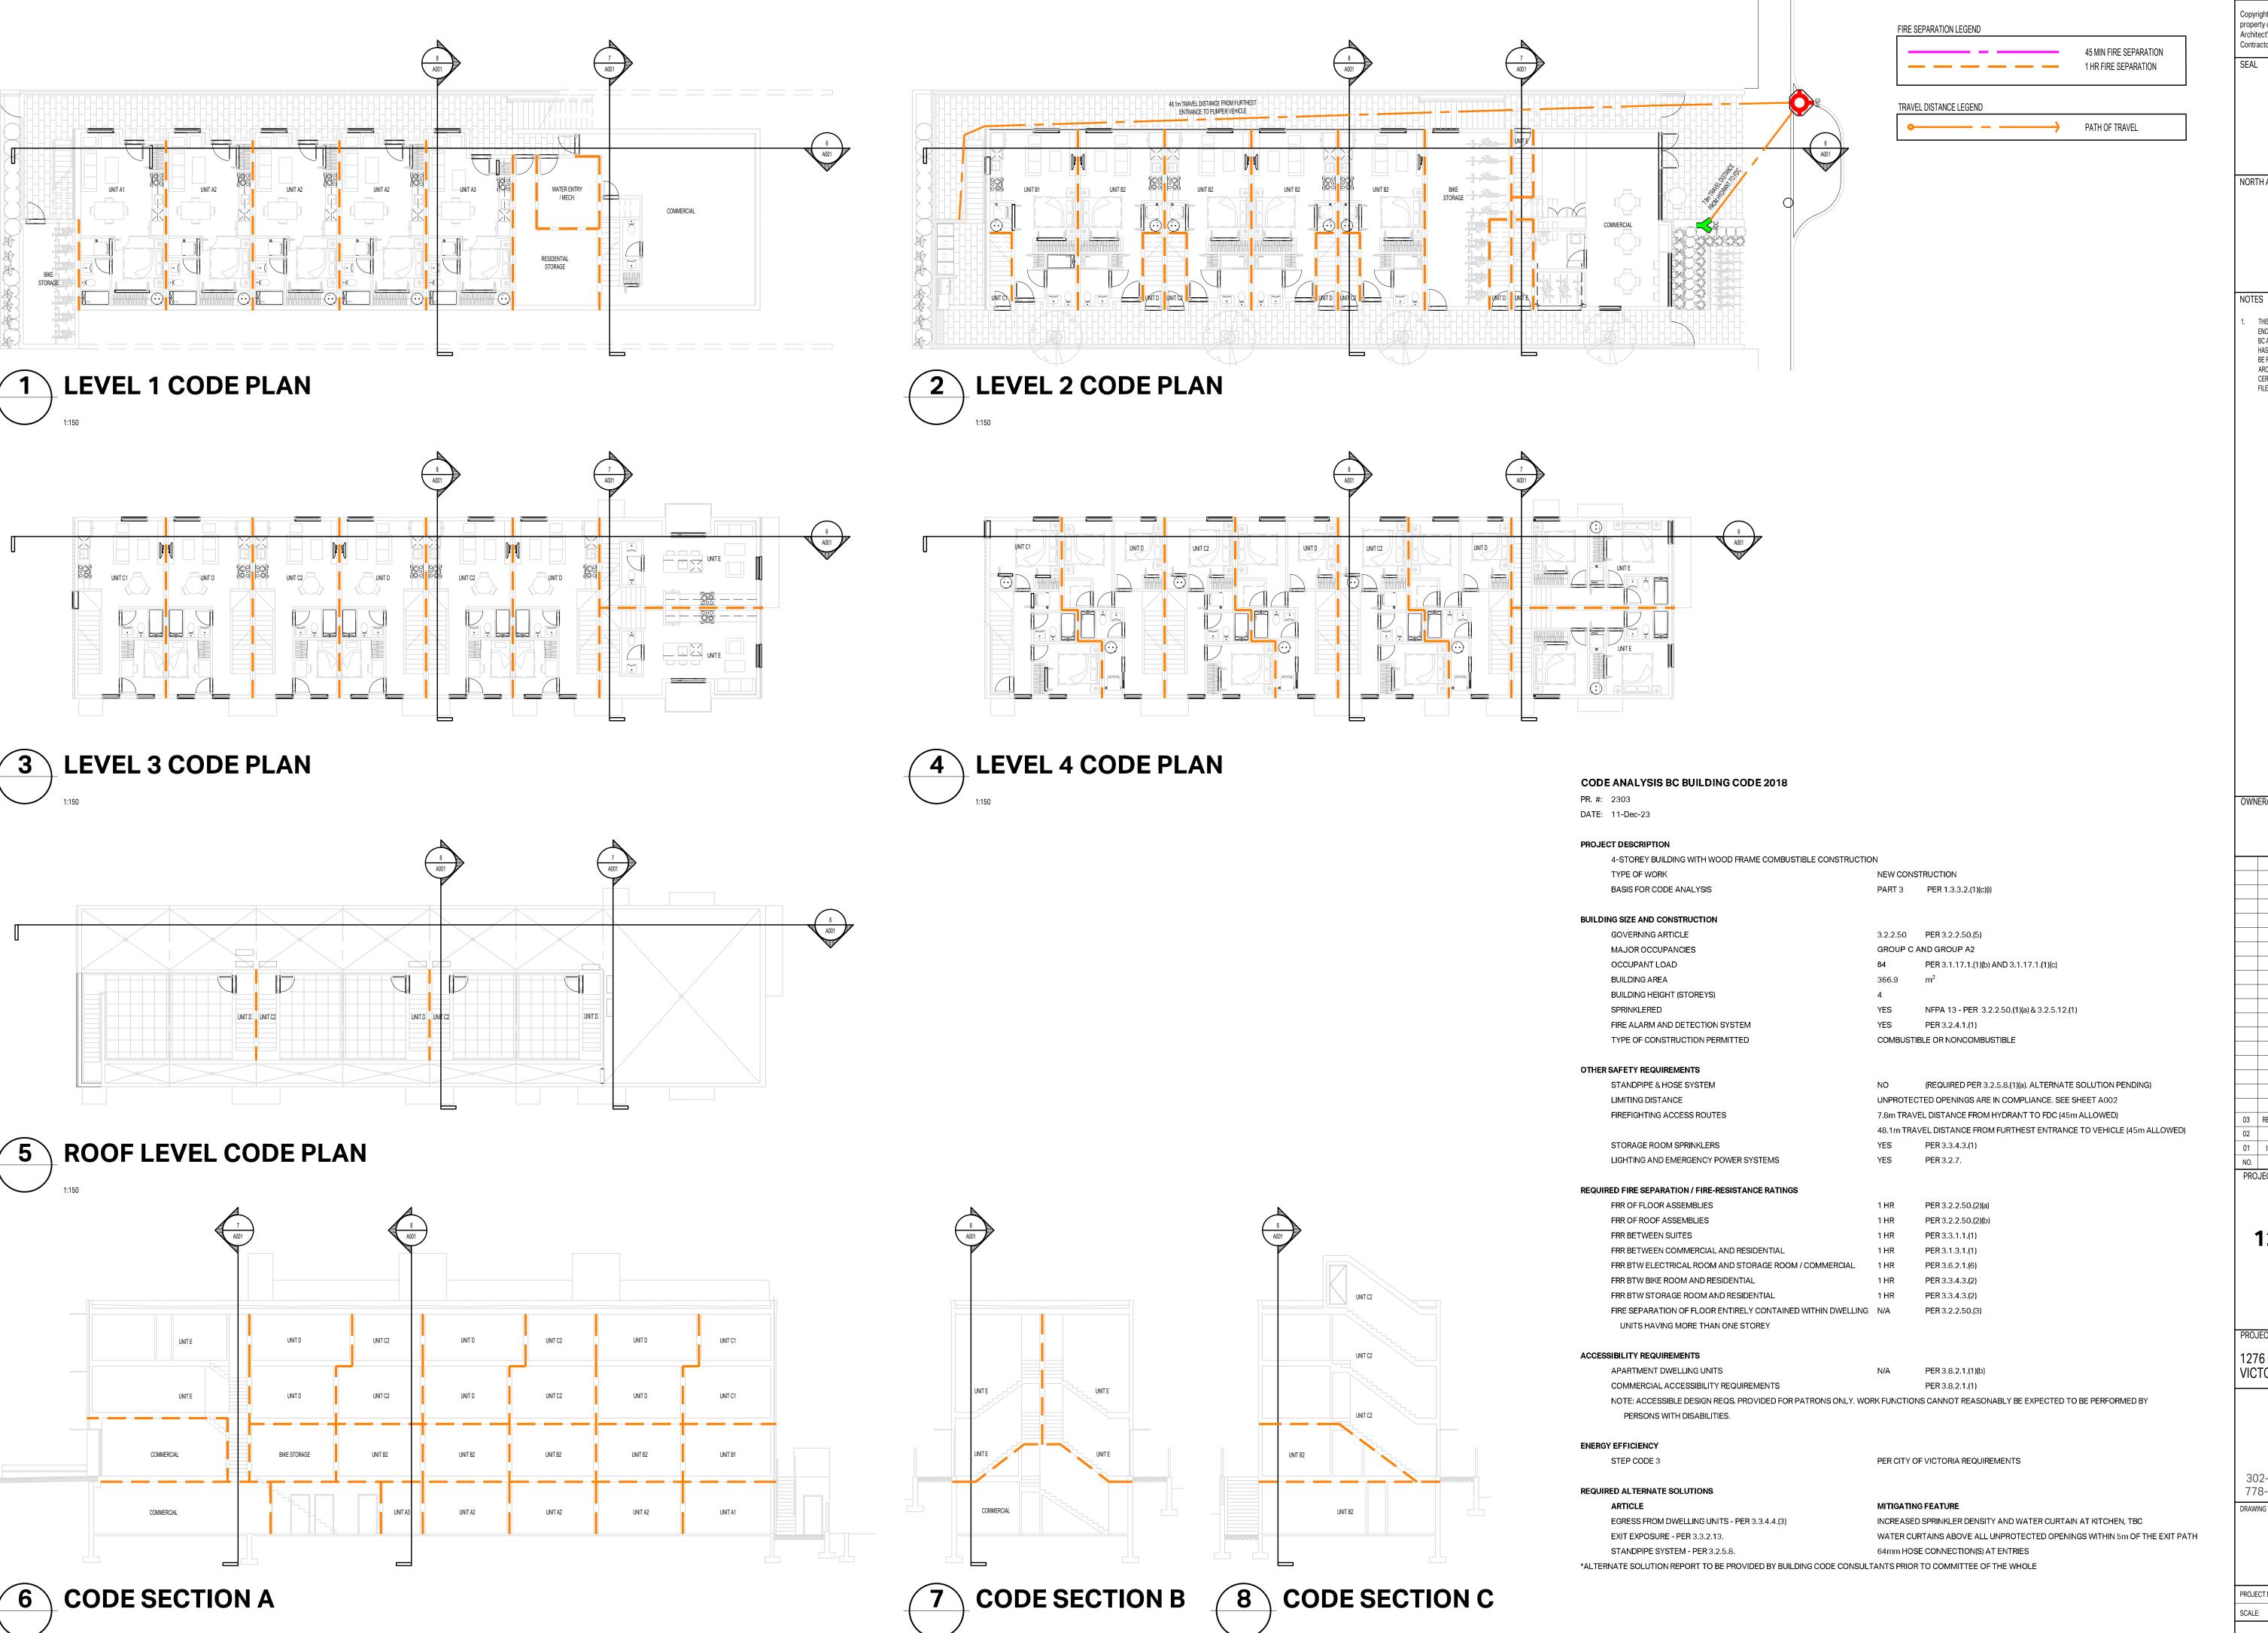


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SCALE: N/A REVIEW BY: CH





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ISSUED FOR REZONING AND DEVELOPMENT PERMIT 09/15/2023 PROJECT NAME

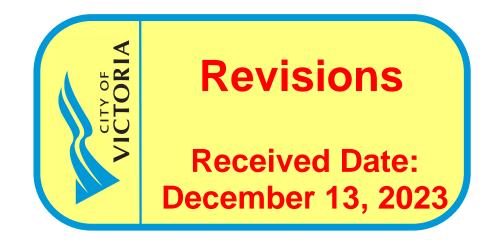1276 GLADSTONE VICTORIA, BC

PROJECT ADDRESS:

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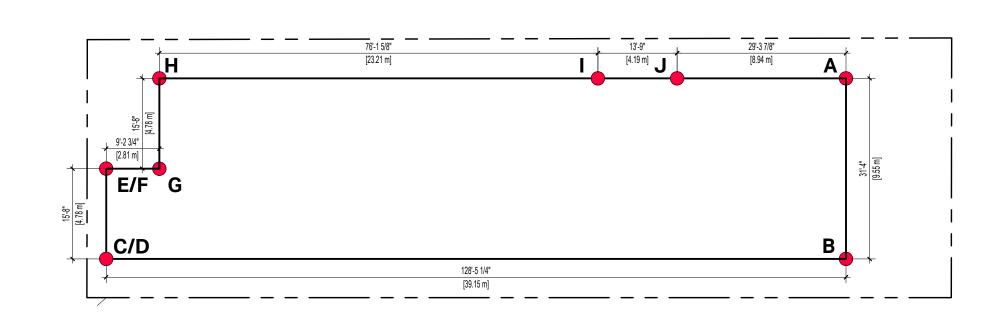



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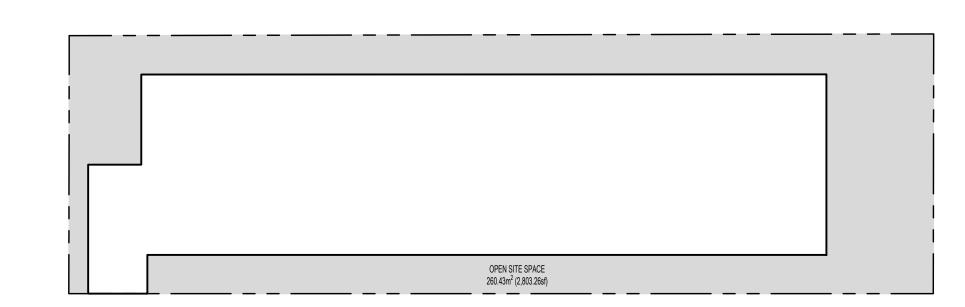
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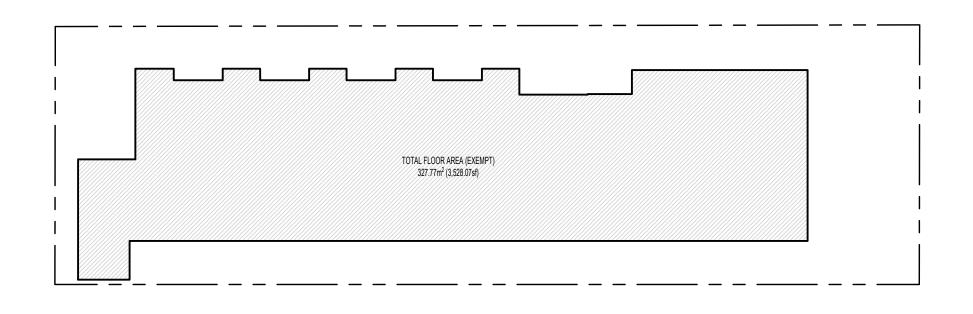
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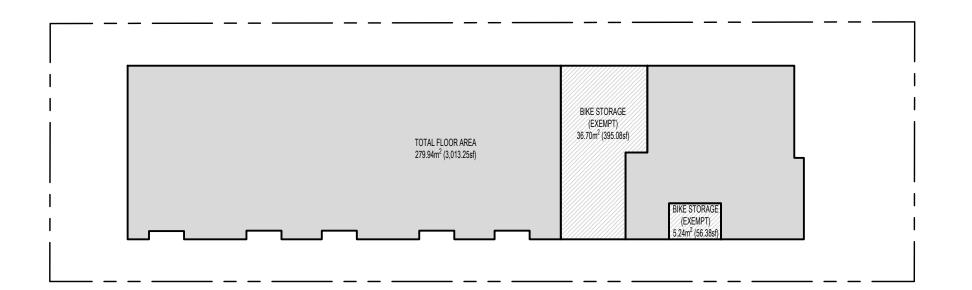
AVERAGE GRADE CALCULATION


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A	31.03	В	31.50	9.55	(31.03 + 31.5) ÷ 2 x 9.55m =	 298.58	Point A	31.03	31.65	31.0
В	31.50	С	29.08	39.15	(31.5 + 29.08) ÷ 2 x 39.15m =	1185.85	Point B	31.50	31.78	31.5
D	29.08	Е	28.77	4.78	(29.08 + 28.77) ÷ 2 x 4.78m =	138.26	Point C	29.08	31.70	29.0
F	28.77	G	28.65	2.81	(28.77 + 28.65) ÷ 2 x 2.81m =	80.68	Point D	29.08	29.08	29.0
G	28.65	Н	28.65	4.78	(28.65 + 28.65) ÷ 2 x 4.78m =	136.95	Point E	28.77	28.77	28.7
Н	28.65	1	28.65	23.21	(28.65 + 28.65) ÷ 2 x 23.21m =	664.97	Point F	28.77	31.65	28.7
I	28.65	J	30.44	4.19	(28.65 + 30.44) ÷ 2 x 4.19m =	123.79	Point G	29.12	28.65	28.6
J	30.44	Α	31.03	8.94	(30.44 + 31.03) ÷ 2 x 8.94m =	274.77	Point H	28.99	28.65	28.6
TO	TALS			97.41		2903.85	Point I	30.02	28.65	28.6
ΑV	ERAGE GR	ADE				29.81	Point J	30.44	31.70	30.4



3 OPEN SITE SPACE




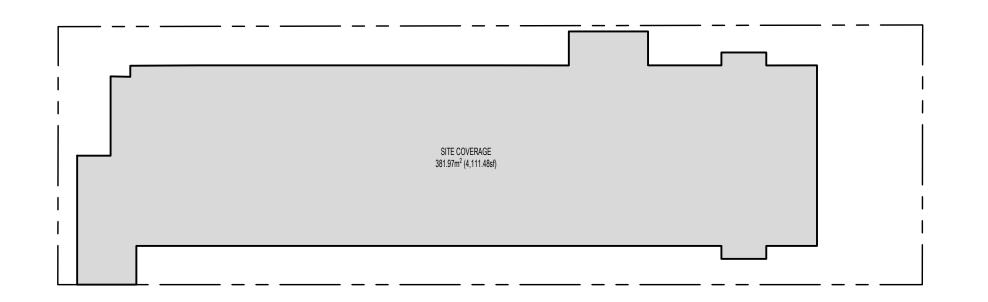

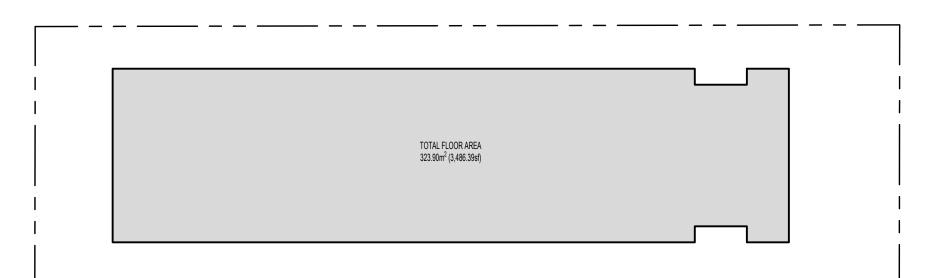


LEVEL 1 FLOOR AREA CALC

LEVEL 2 FLOOR AREA CALC

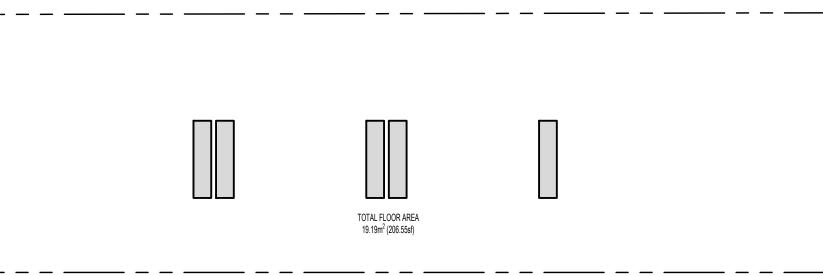



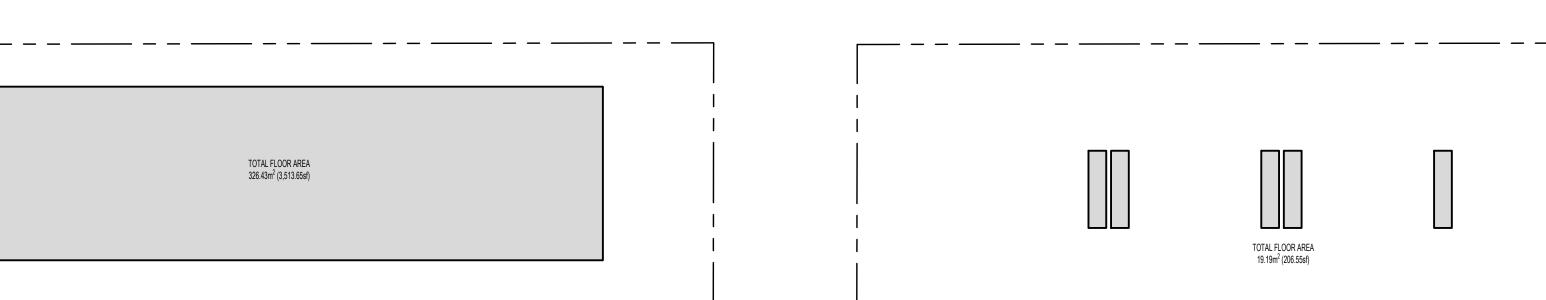

ROOF LEVEL FLOOR AREA CALC

VICTORIA, BC PROJECT ADDRESS:

1276 GLADSTONE

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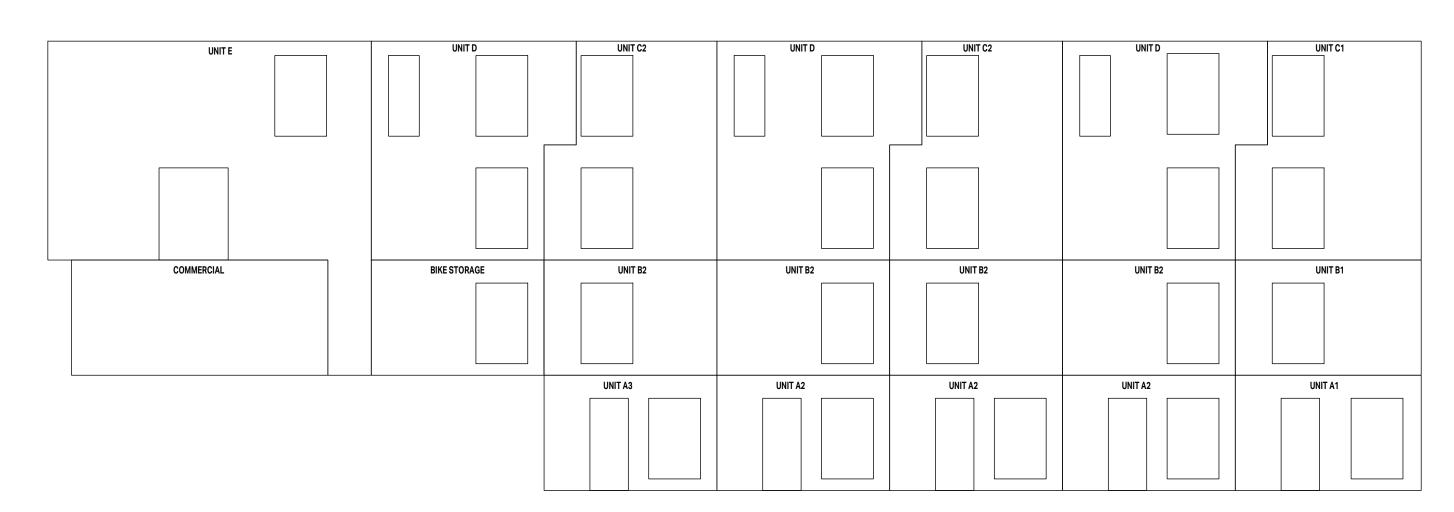
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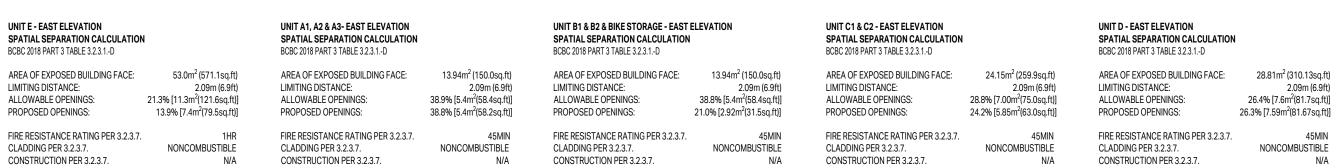


AREA CALCULATIONS


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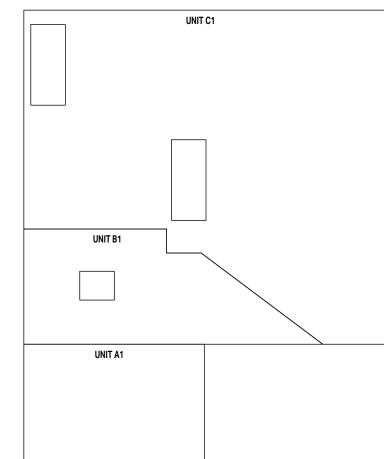


EAST ELEVATION




UNIT B1 & B2 - WEST ELEVATION SPATIAL SEPARATION CALCULATION BCBC 2018 PART 3 TABLE 3.2.3.1D	ı	UNIT C1 & C2 - WEST ELEVATION SPATIAL SEPARATION CALCULATION BCBC 2018 PART 3 TABLE 3.2.3.1D	ı	UNIT D- WEST ELEVATION SPATIAL SEPARATION CALCULATIO BCBC 2018 PART 3 TABLE 3.2.3.1D	N	UNIT E - WEST ELEVATION SPATIAL SEPARATION CALCULATIO BCBC 2018 PART 3 TABLE 3.2.3.1D	N	COMMERCIAL - WEST ELEVATION SPATIAL SEPARATION CALCULATION BCBC 2018 PART 3 TABLE 3.2.3.1D	ı
AREA OF EXPOSED BUILDING FACE: LIMITING DISTANCE: ALLOWABLE OPENINGS: PROPOSED OPENINGS:	10.43m² (112.3sq.ft) 2.08m (6.8ft) 45.0% [4.7m²(50.6sq.ft)] 23.8% [2.48m²(26.7sq.ft)]	AREA OF EXPOSED BUILDING FACE: LIMITING DISTANCE: ALLOWABLE OPENINGS: PROPOSED OPENINGS:	33.46m² (360.2sq.ft) 2.08m (6.8ft) 24.8% [8.3m²(89.3sq.ft)] 23.3% [7.80m²(84.0sq.ft)]	AREA OF EXPOSED BUILDING FACE: LIMITING DISTANCE: ALLOWABLE OPENINGS: PROPOSED OPENINGS:	26.50m ² (285.2sq,ft) 2.08m (6.8ft) 27.2% [7.2m ² (77.7sq,ft)] 22.1% [5.85m ² (63.00sq,ft)]	AREA OF EXPOSED BUILDING FACE: LIMITING DISTANCE: ALLOWABLE OPENINGS: PROPOSED OPENINGS:	53.0m ² (571.1sq.ft) 2.08m (6.8ft) 21.2% [11.3m ² (121.1sq.ft)] 13.9% [7.4m ² (79.5sq.ft)]	AREA OF EXPOSED BUILDING FACE: LIMITING DISTANCE: ALLOWABLE OPENINGS: PROPOSED OPENINGS:	22.6m² (243.0sq.ft) 2.08m (6.8ft) 29.8% [6.7m²(72.4sq.ft)] 12.3% [2.8m²(30.0sq.ft)]
FIRE RESISTANCE RATING PER 3.2.3.7.	45MIN	FIRE RESISTANCE RATING PER 3.2.3.7.	1HR	FIRE RESISTANCE RATING PER 3.2.3.7	. 45MIN	FIRE RESISTANCE RATING PER 3.2.3.7	. 1HR	FIRE RESISTANCE RATING PER 3.2.3.7.	45MIN
CLADDING PER 3.2.3.7.	NONCOMBUSTIBLE	CLADDING PER 3.2.3.7.	NONCOMBUSTIBLE	CLADDING PER 3.2.3.7.	NONCOMBUSTIBLE	CLADDING PER 3.2.3.7.	NONCOMBUSTIBLE	CLADDING PER 3.2.3.7.	NONCOMBUSTIBLE
CONSTRUCTION PER 3.2.3.7.	N/A	CONSTRUCTION PER 3.2.3.7.	N/A	CONSTRUCTION PER 3.2.3.7.	N/A	CONSTRUCTION PER 3.2.3.7.	N/A	CONSTRUCTION PER 3.2.3.7.	N/A



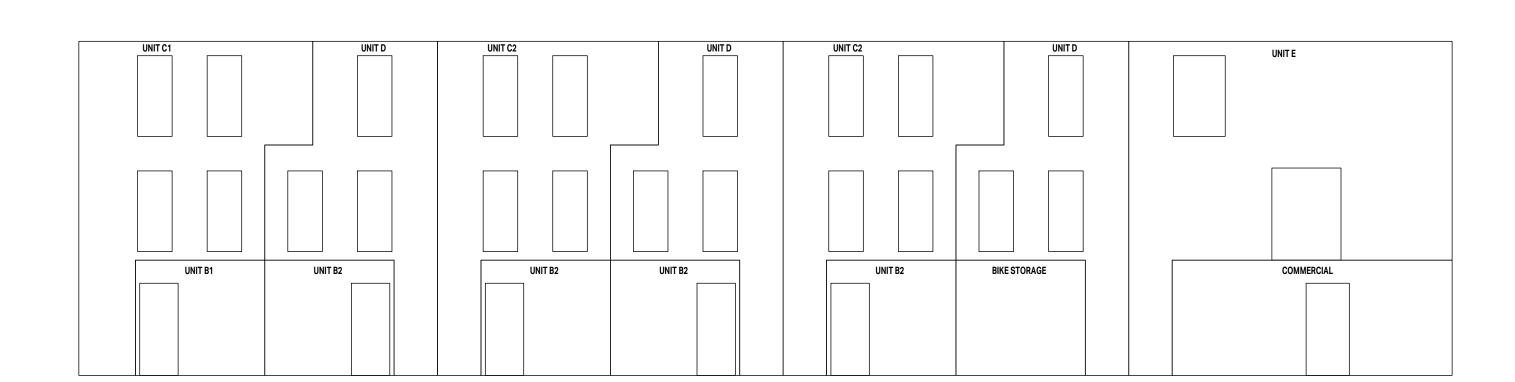


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UNIT B1 - NORTH ELEVATION SPATIAL SEPARATION CALCULATION BCBC 2018 PART 3 TABLE 3.2.3.1D	PARATION CALCULATION SPATIAL SEPARATION CALCULATION		N
AREA OF EXPOSED BUILDING FACE:	17.6m² (189.5sq.ft)	AREA OF EXPOSED BUILDING FACE:	66.8m² (719.2sq.ft)
LIMITING DISTANCE:	3.96m (12.99ft)	LIMITING DISTANCE:	3.96m (12.99ft)
ALLOWABLE OPENINGS:	98.7% [17.4m²(186.9sq.ft)]	ALLOWABLE OPENINGS:	46.6% [31.1m²(335.2sq.ft)]
PROPOSED OPENINGS:	4.0% [0.7m²(7.5sq.ft)]	PROPOSED OPENINGS:	5.8% [3.9m²(42.0sq.ft)]
FIRE RESISTANCE RATING PER 3.2.3.7.	45MIN	FIRE RESISTANCE RATING PER 3.2.3.7.	45MIN
CLADDING PER 3.2.3.7.	N/A	CLADDING PER 3.2.3.7.	N/A
CONSTRUCTION PER 3.2.3.7.	N/A	CONSTRUCTION PER 3.2.3.7.	N/A



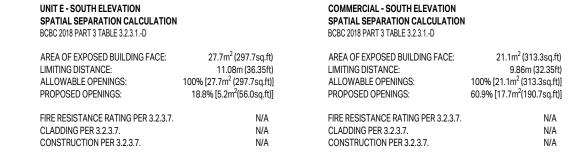






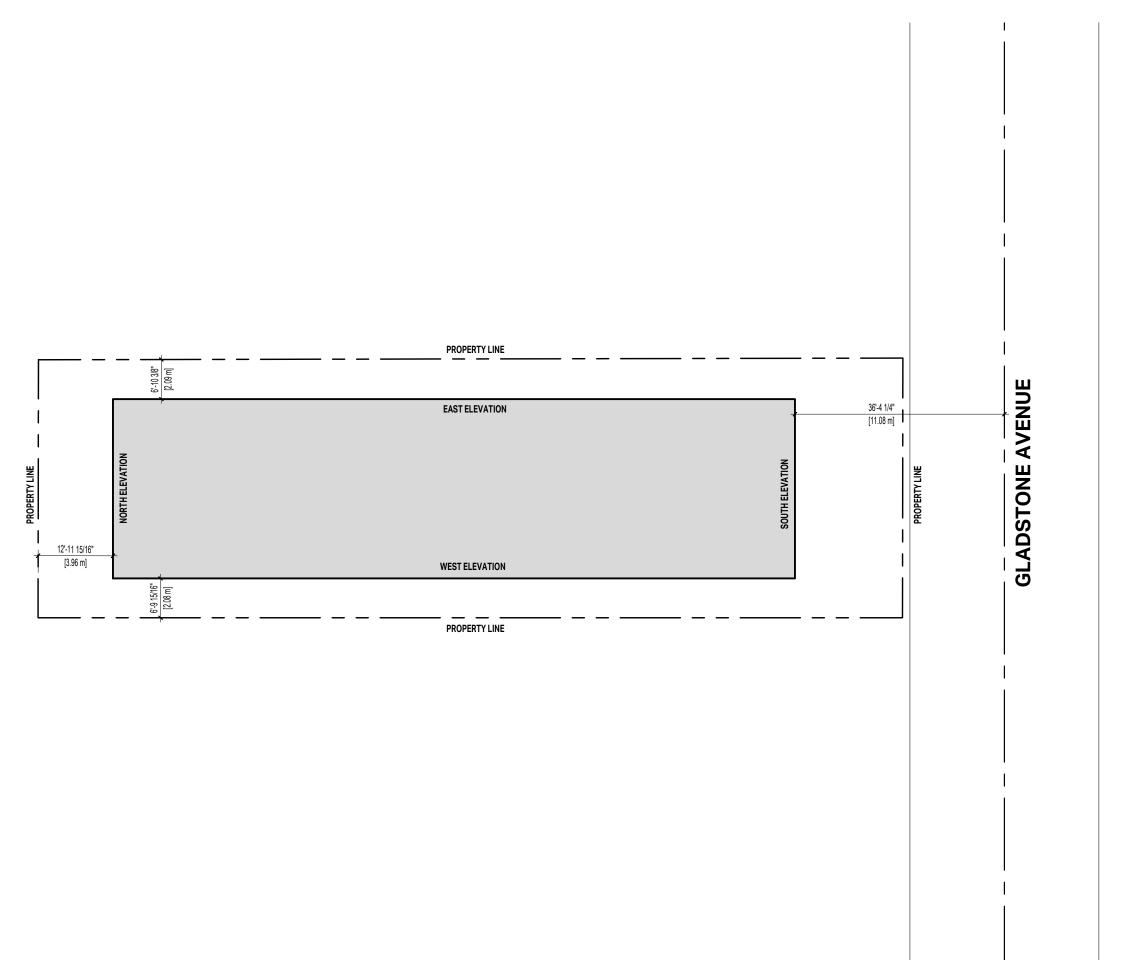

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02	ISSUED FOR REVIEW	11/03/2
01	ISSUED FOR REZONING AND DEVELOPMENT PERMIT	09/15/2

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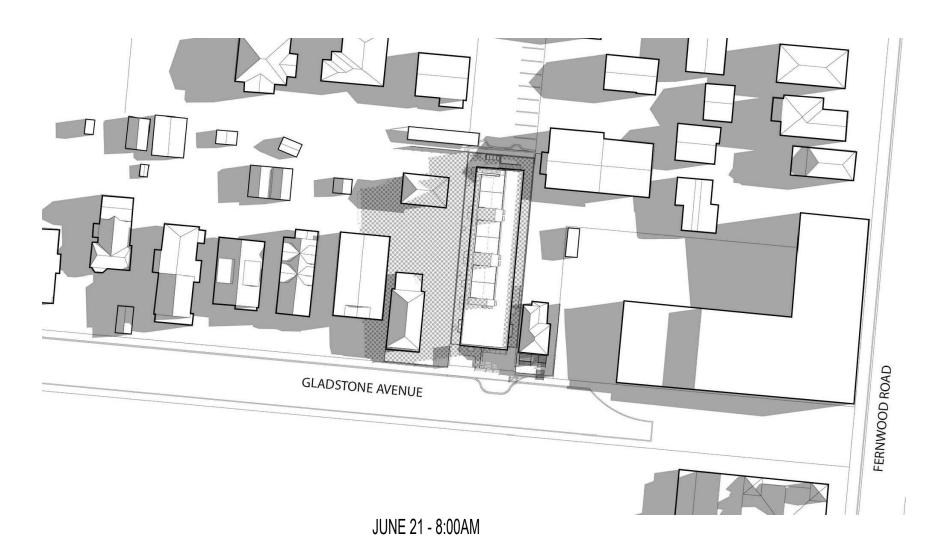
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LIMITING DISTANCE

PROJECT NO: 2303 DRAWN BY: KG SCALE: 1:100 REVIEW BY: CH			DRAWING NO.	Δ 003
PROJECT NO: 2303 DRAWN BY: KG	SCALE:	1:100	REVIEW BY:	СН
	PROJECT NO:	2303	DRAWN BY:	KG

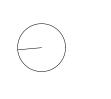







JUNE 21 - 5:00PM

JUNE 21 - 12:00PM





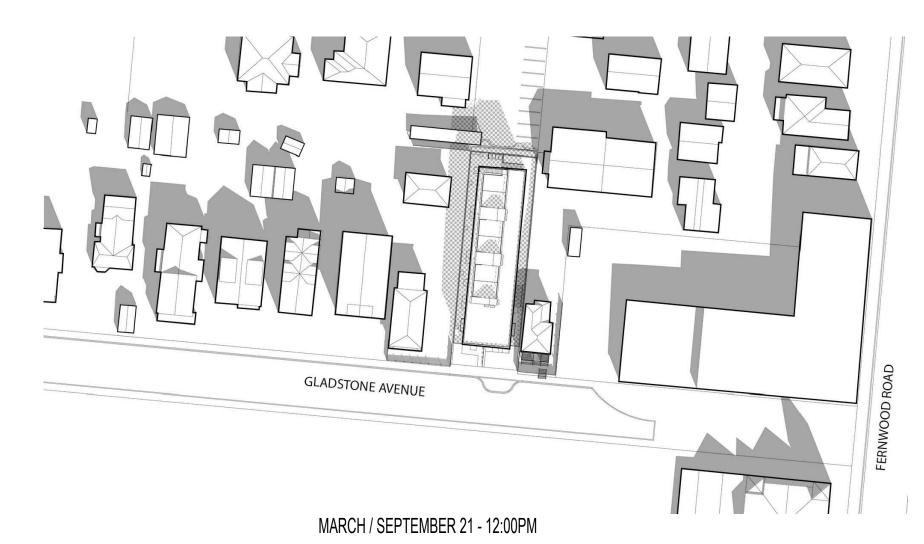


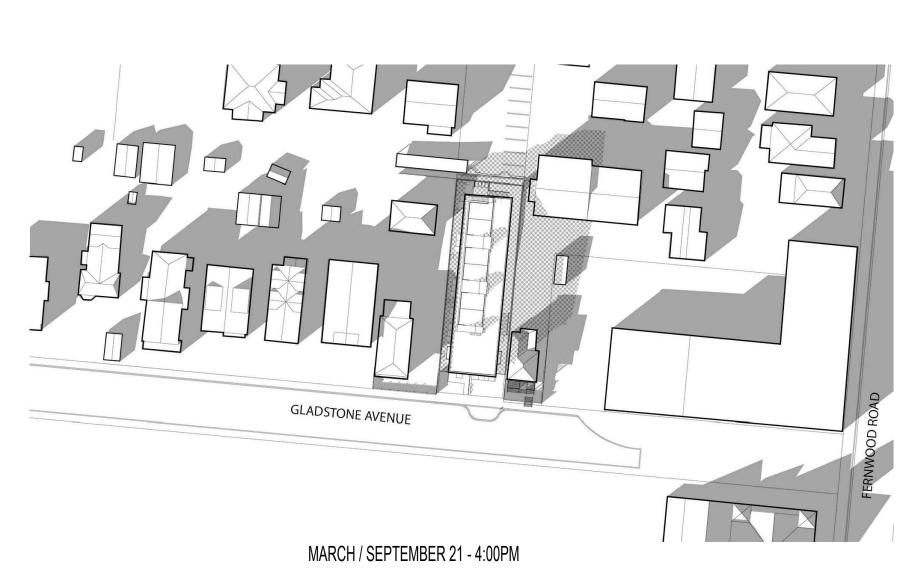

MARCH / SEPTEMBER 21 - 9:00AM



DECEMBER 21 - 12:00PM

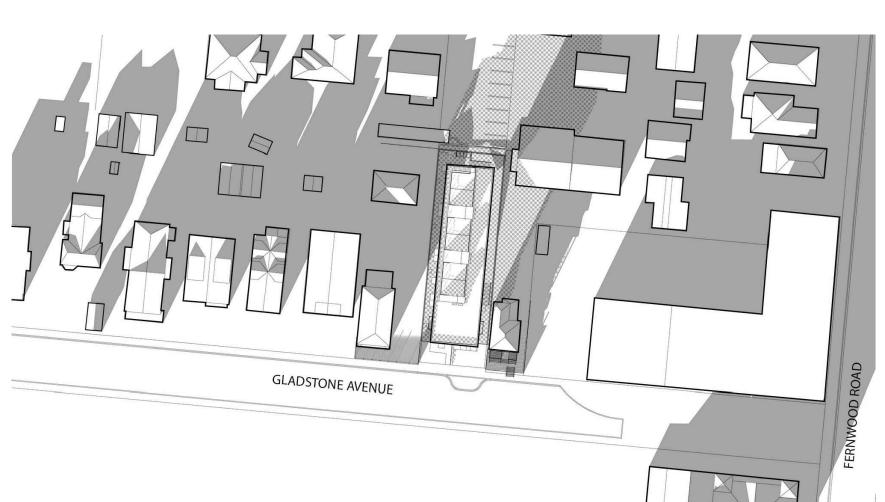

DECEMBER 21 - 10:00AM



GLADSTONE AVENUE

- SHADOWS FROM EXISTING BUILDINGS
- SHADOWS FROM PROPOSED BUILDING
- SHADOW OVERLAY OF PROPOSED & EXISTING BUILDINGS



DECEMBER 21 - 3:00PM

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PROJECT NAME


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SHADOW STUDY

PROJECT NO: 2303 REVIEW BY: DRAWING NO: A005







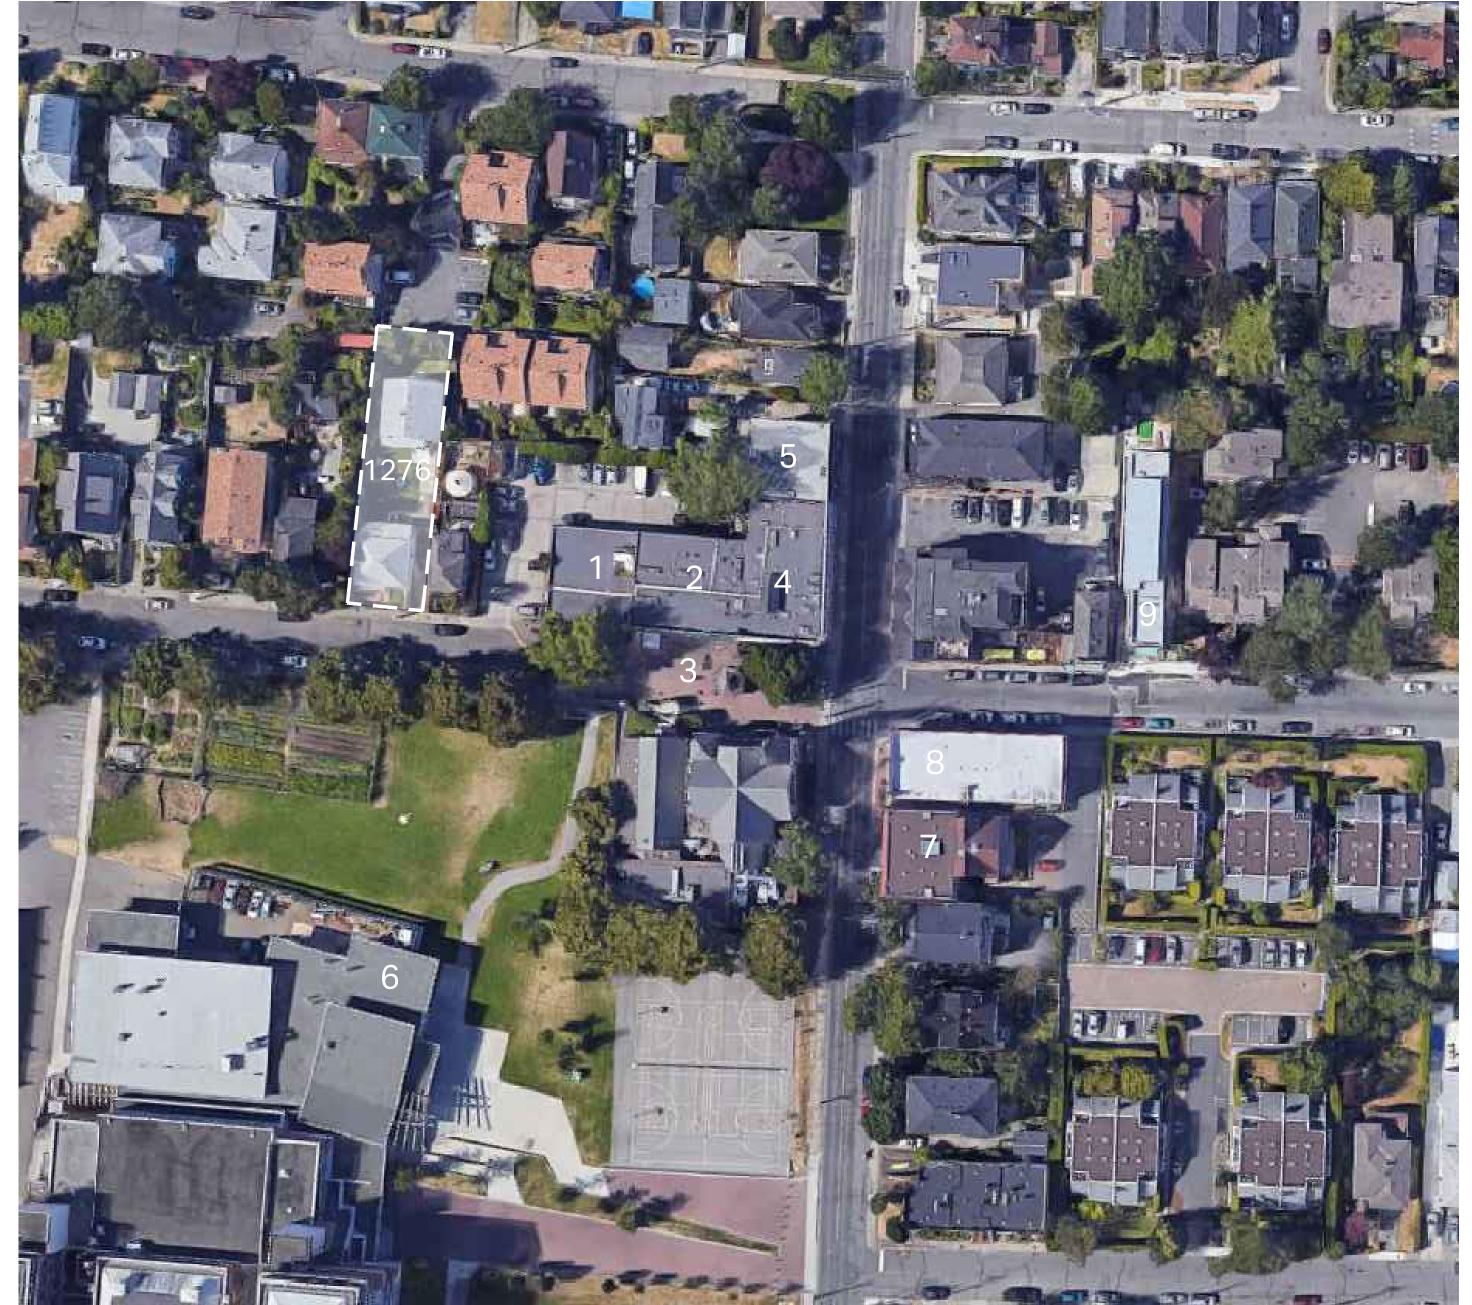














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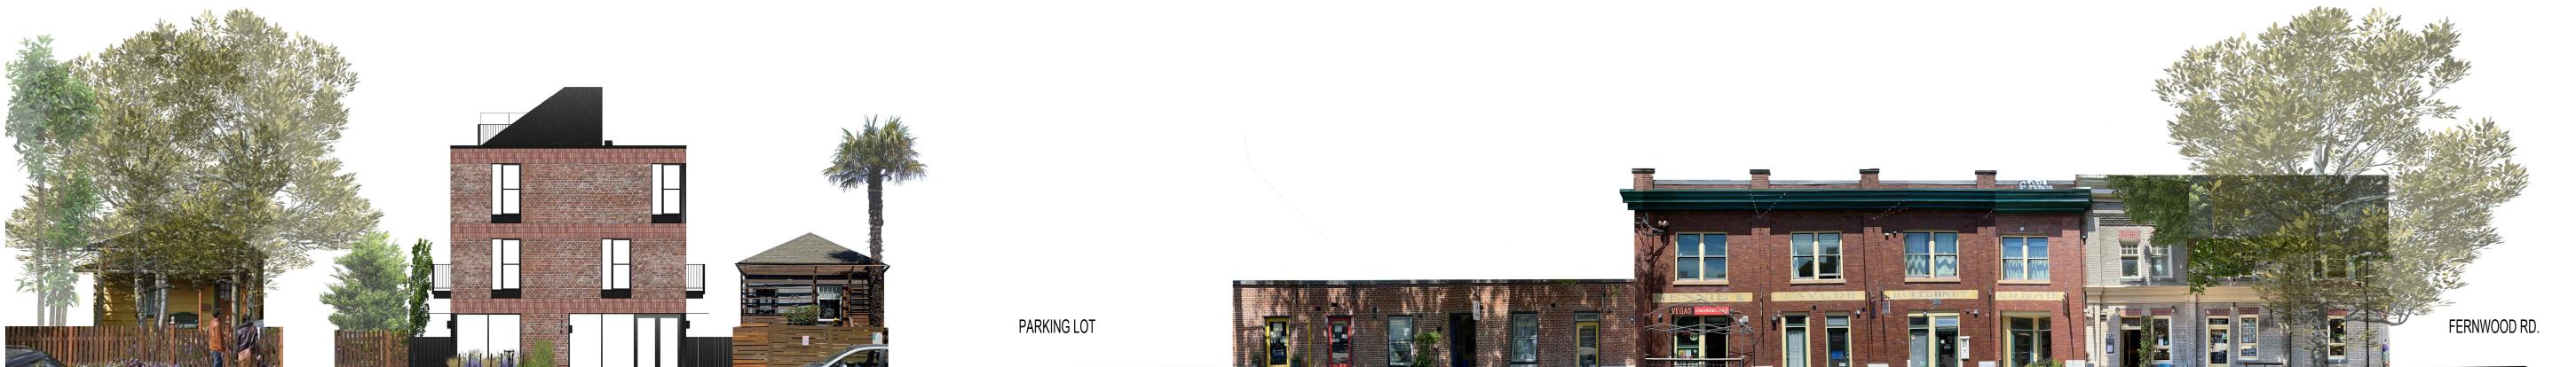
CONTEXT PLAN & STREETSCAPE

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SCALE: N/A REVIEW BY: CH

DRAWING NO: A006

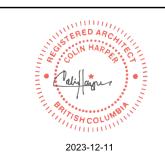




1270 GLADSTONE AVE. 1276 GLADSTONE AVE.

1280 GLADSTONE AVE. 1298 GLADSTONE AVE.

1292 GLADSTONE AVE.

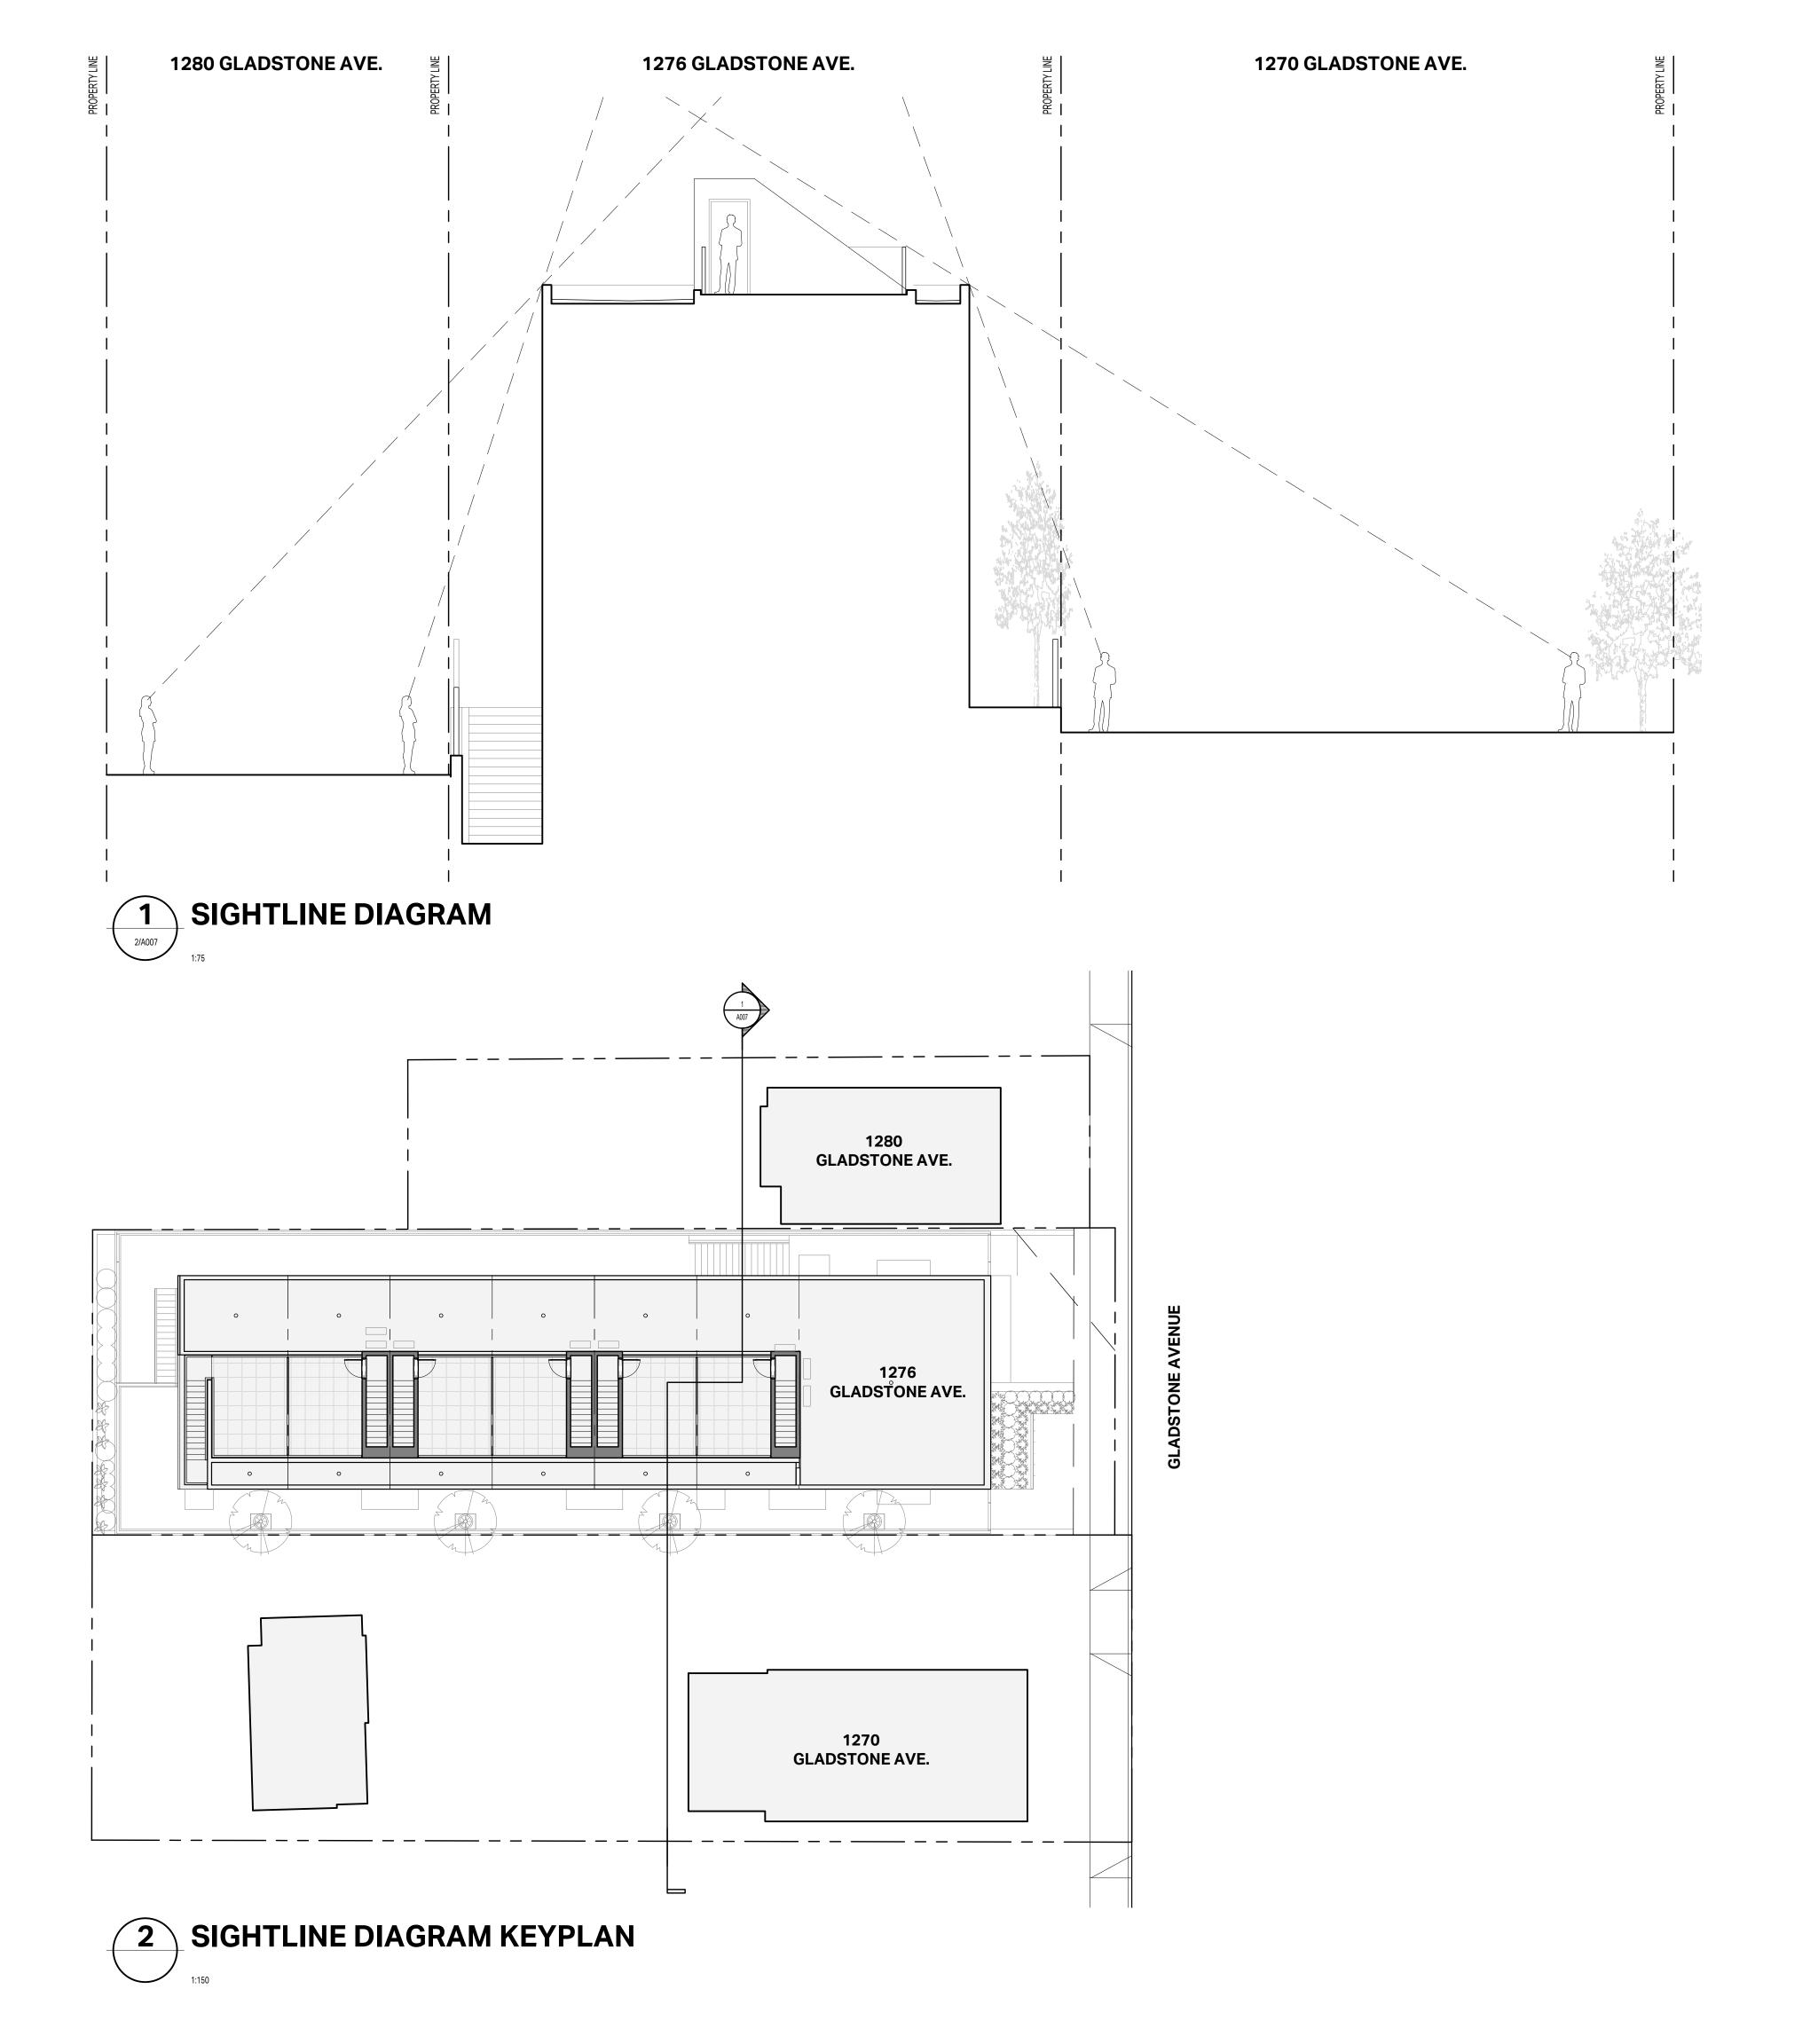

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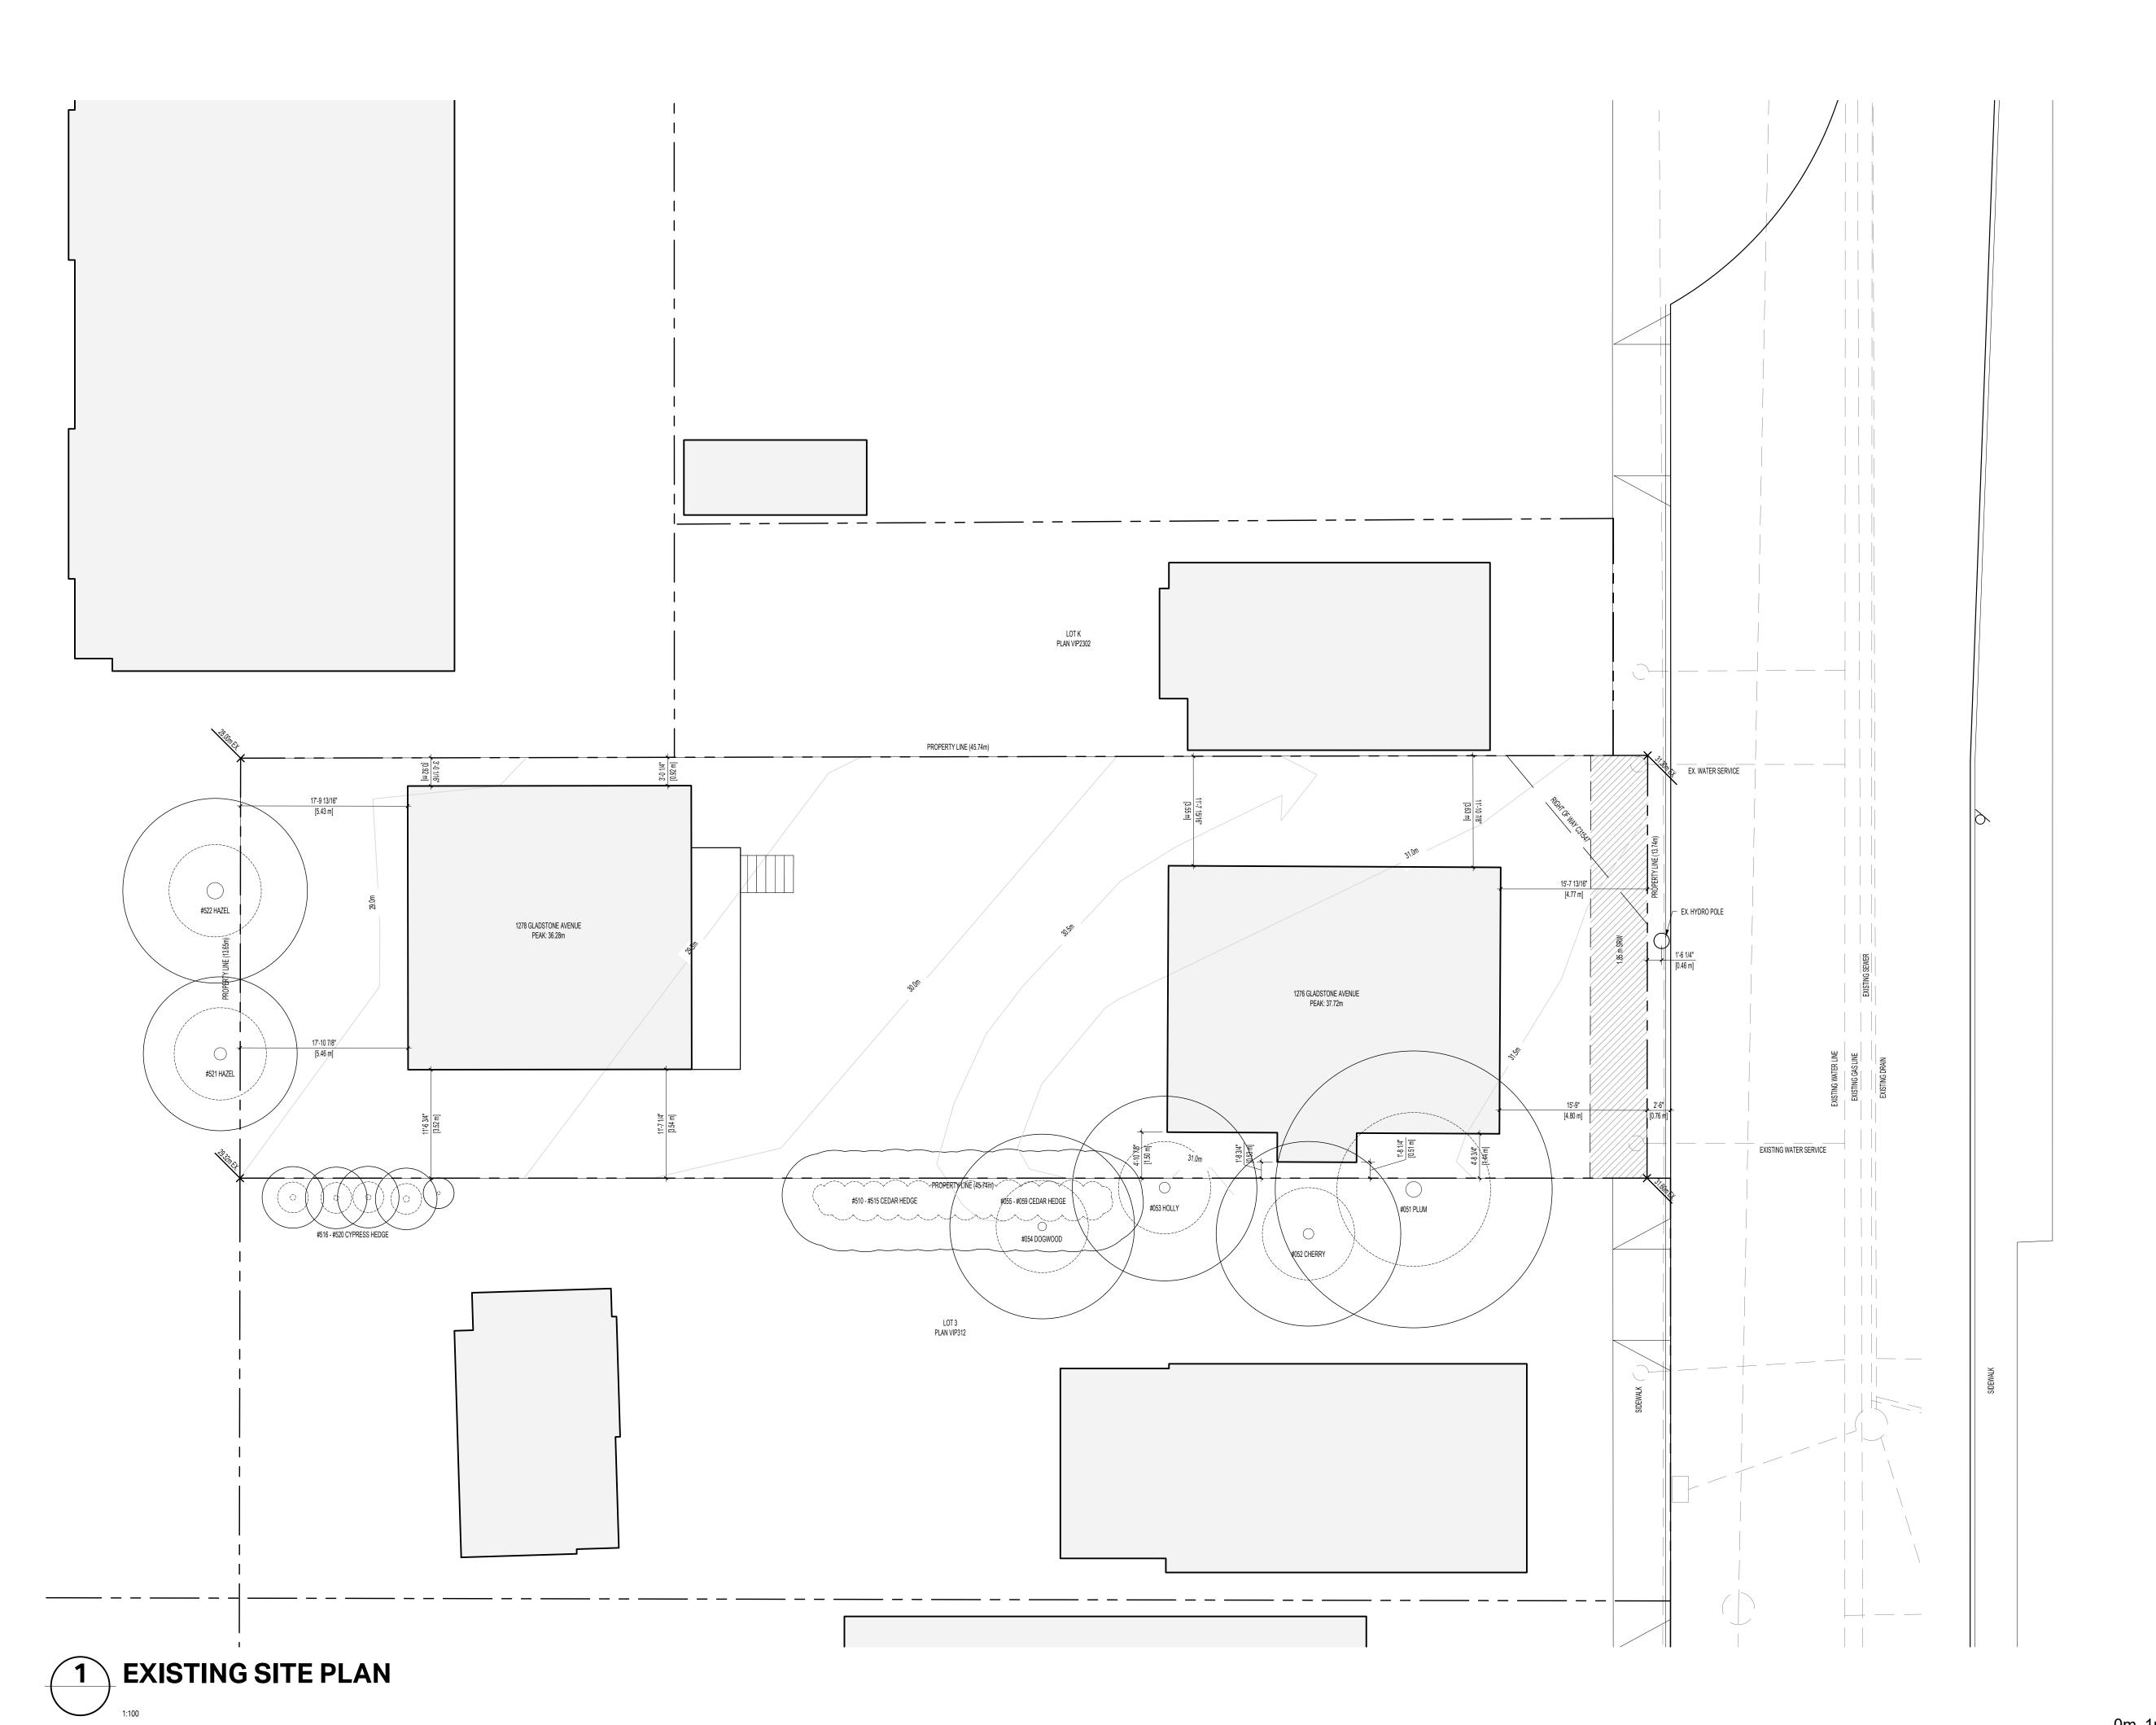
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SIGHTLINE DIAGRAM


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 2303
 DRAWN BY:
 KG

 SCALE:
 1:75
 REVIEW BY:
 CH

DRAWING NO: A007



| SEA

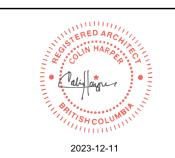


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TREE LEGEND



NOTE: SEE ARBORIST REPORT AND LANDSCAPE DRAWINGS FOR ADDITIONAL INFORMATION ON CR7 AND RETENTION MEASURES

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P. ISSUED FOR REVIEW 11/03/2023
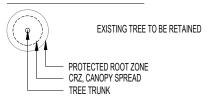
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 12/11/2023

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 11/03/2023

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 PROJECT NAME

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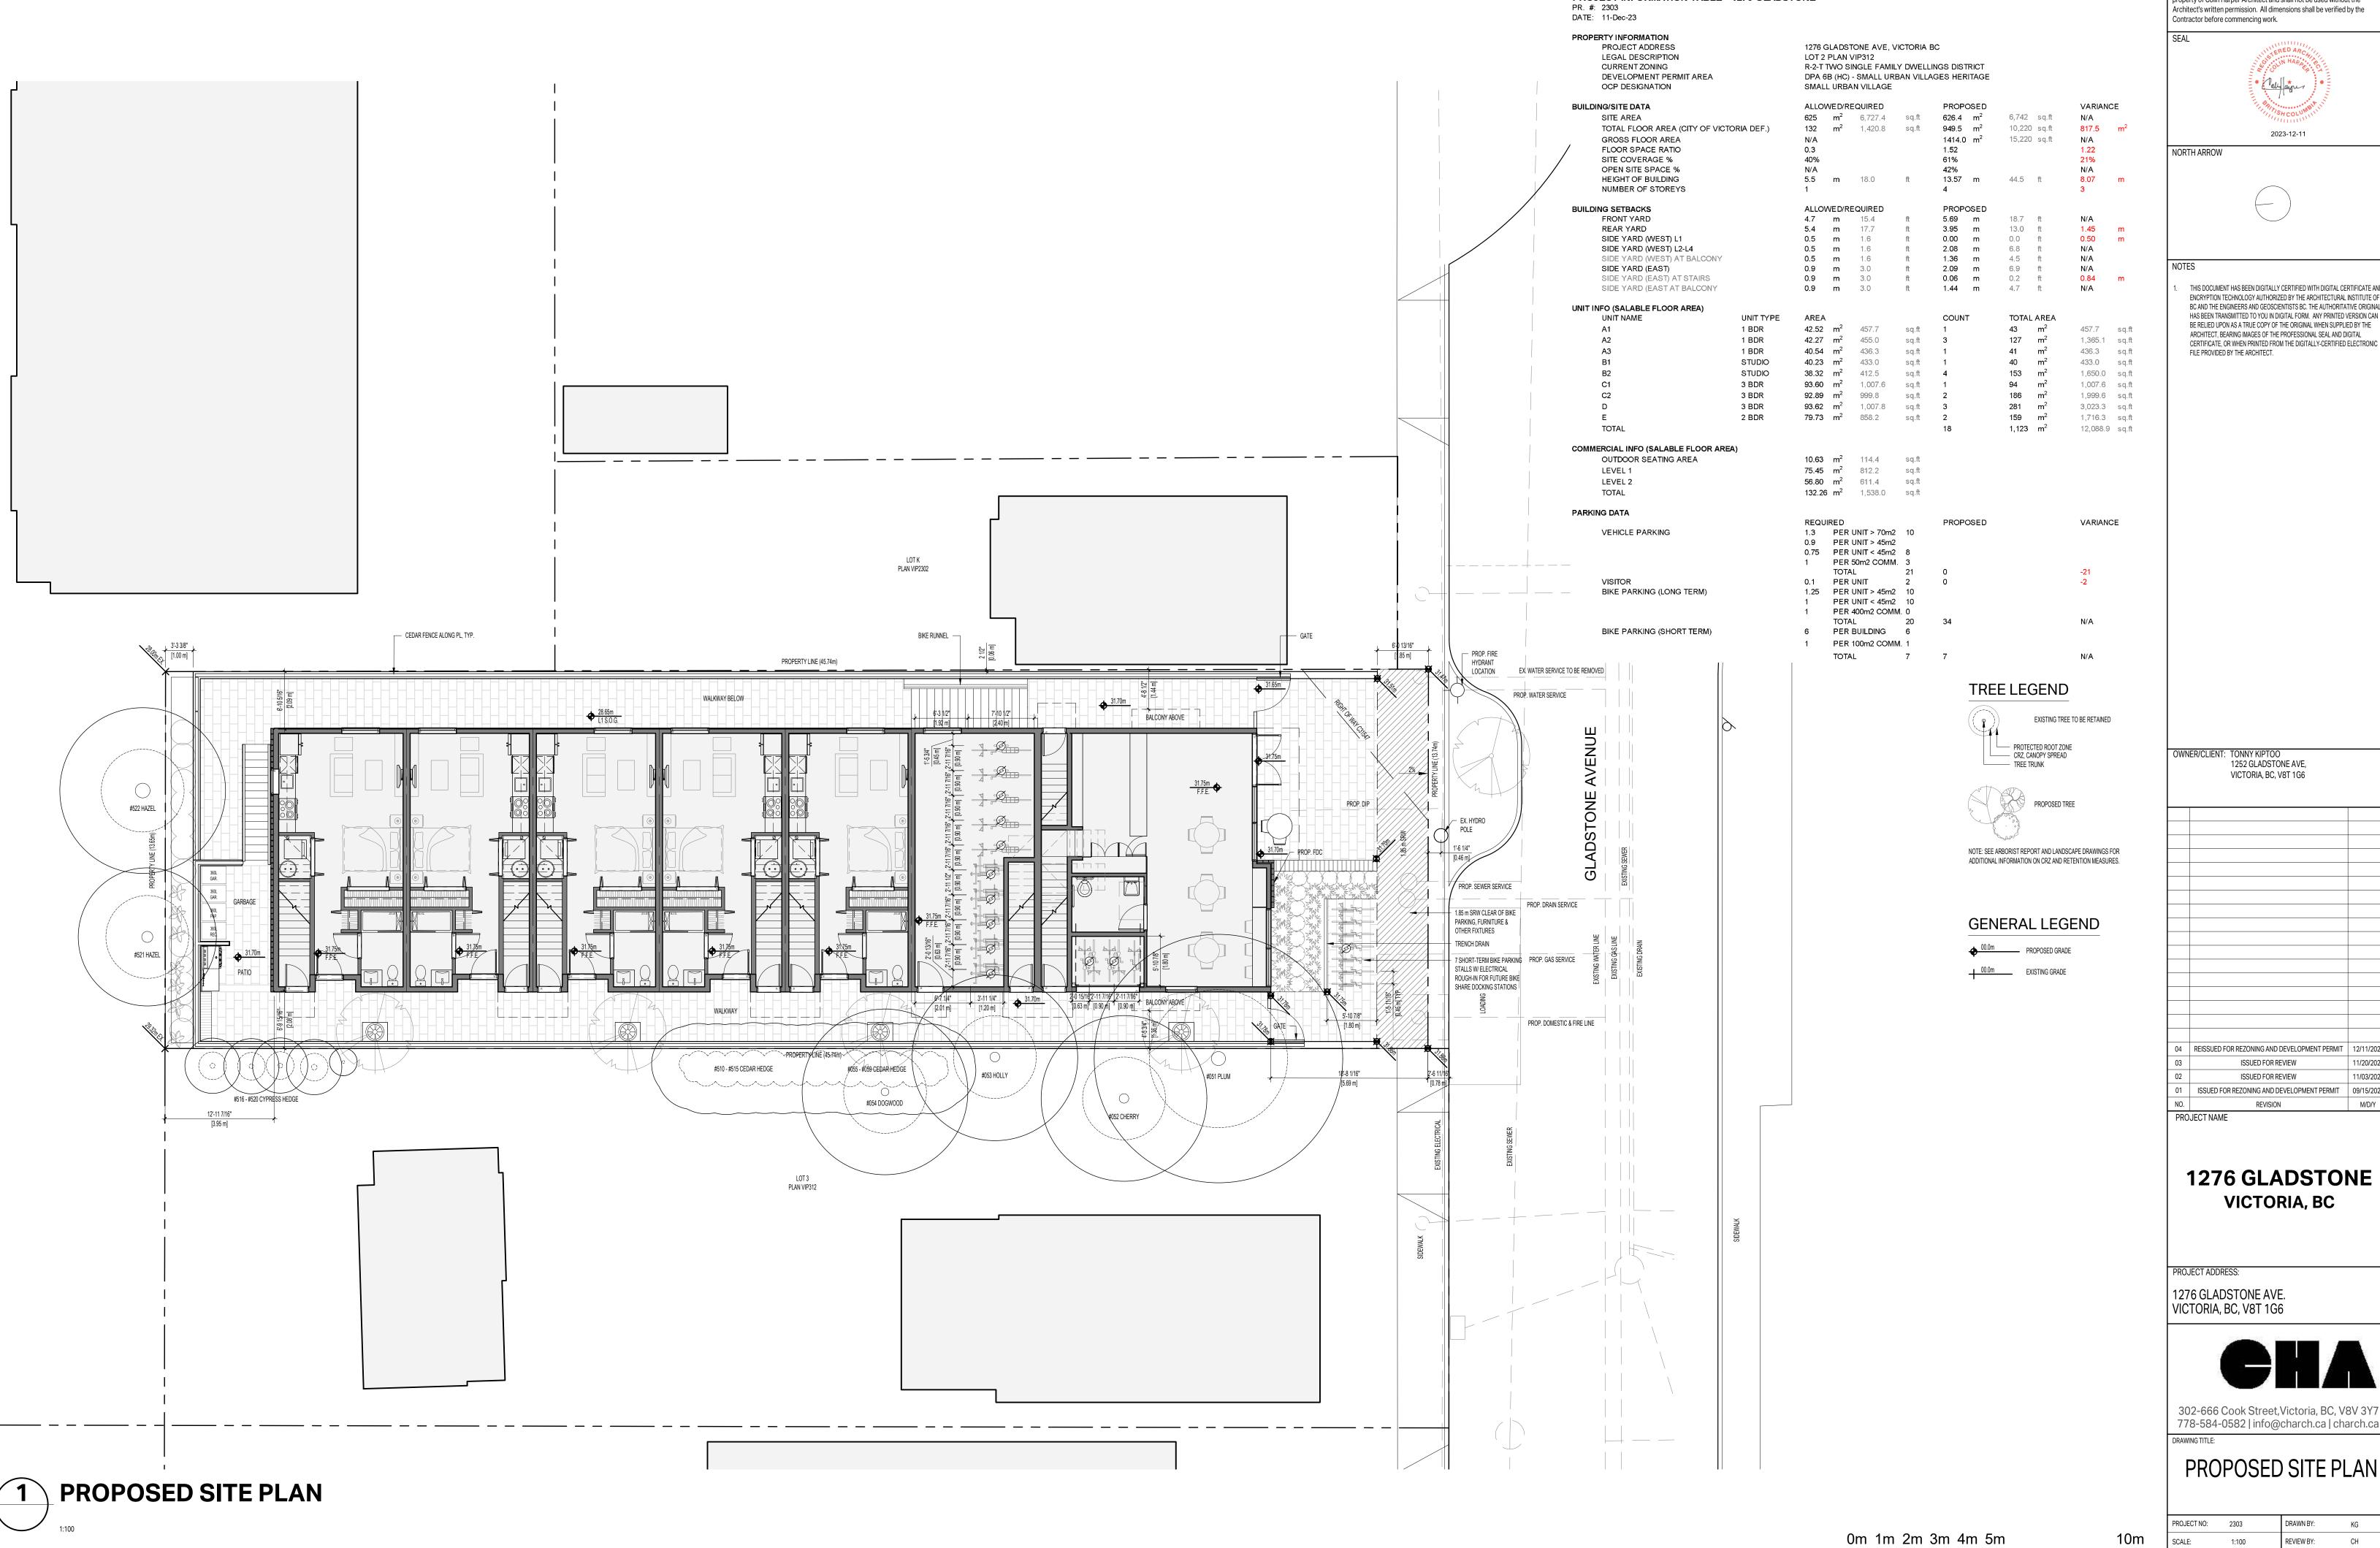
EXISTING SITE PLAN

 PROJECT NO:
 2303
 DRAWN BY:
 KG

 SCALE:
 1:100
 REVIEW BY:
 CH

 DRAWING NO:
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0m 1m 2m 3m 4m 5m



PROJECT INFORMATION TABLE - 1276 GLADSTONE

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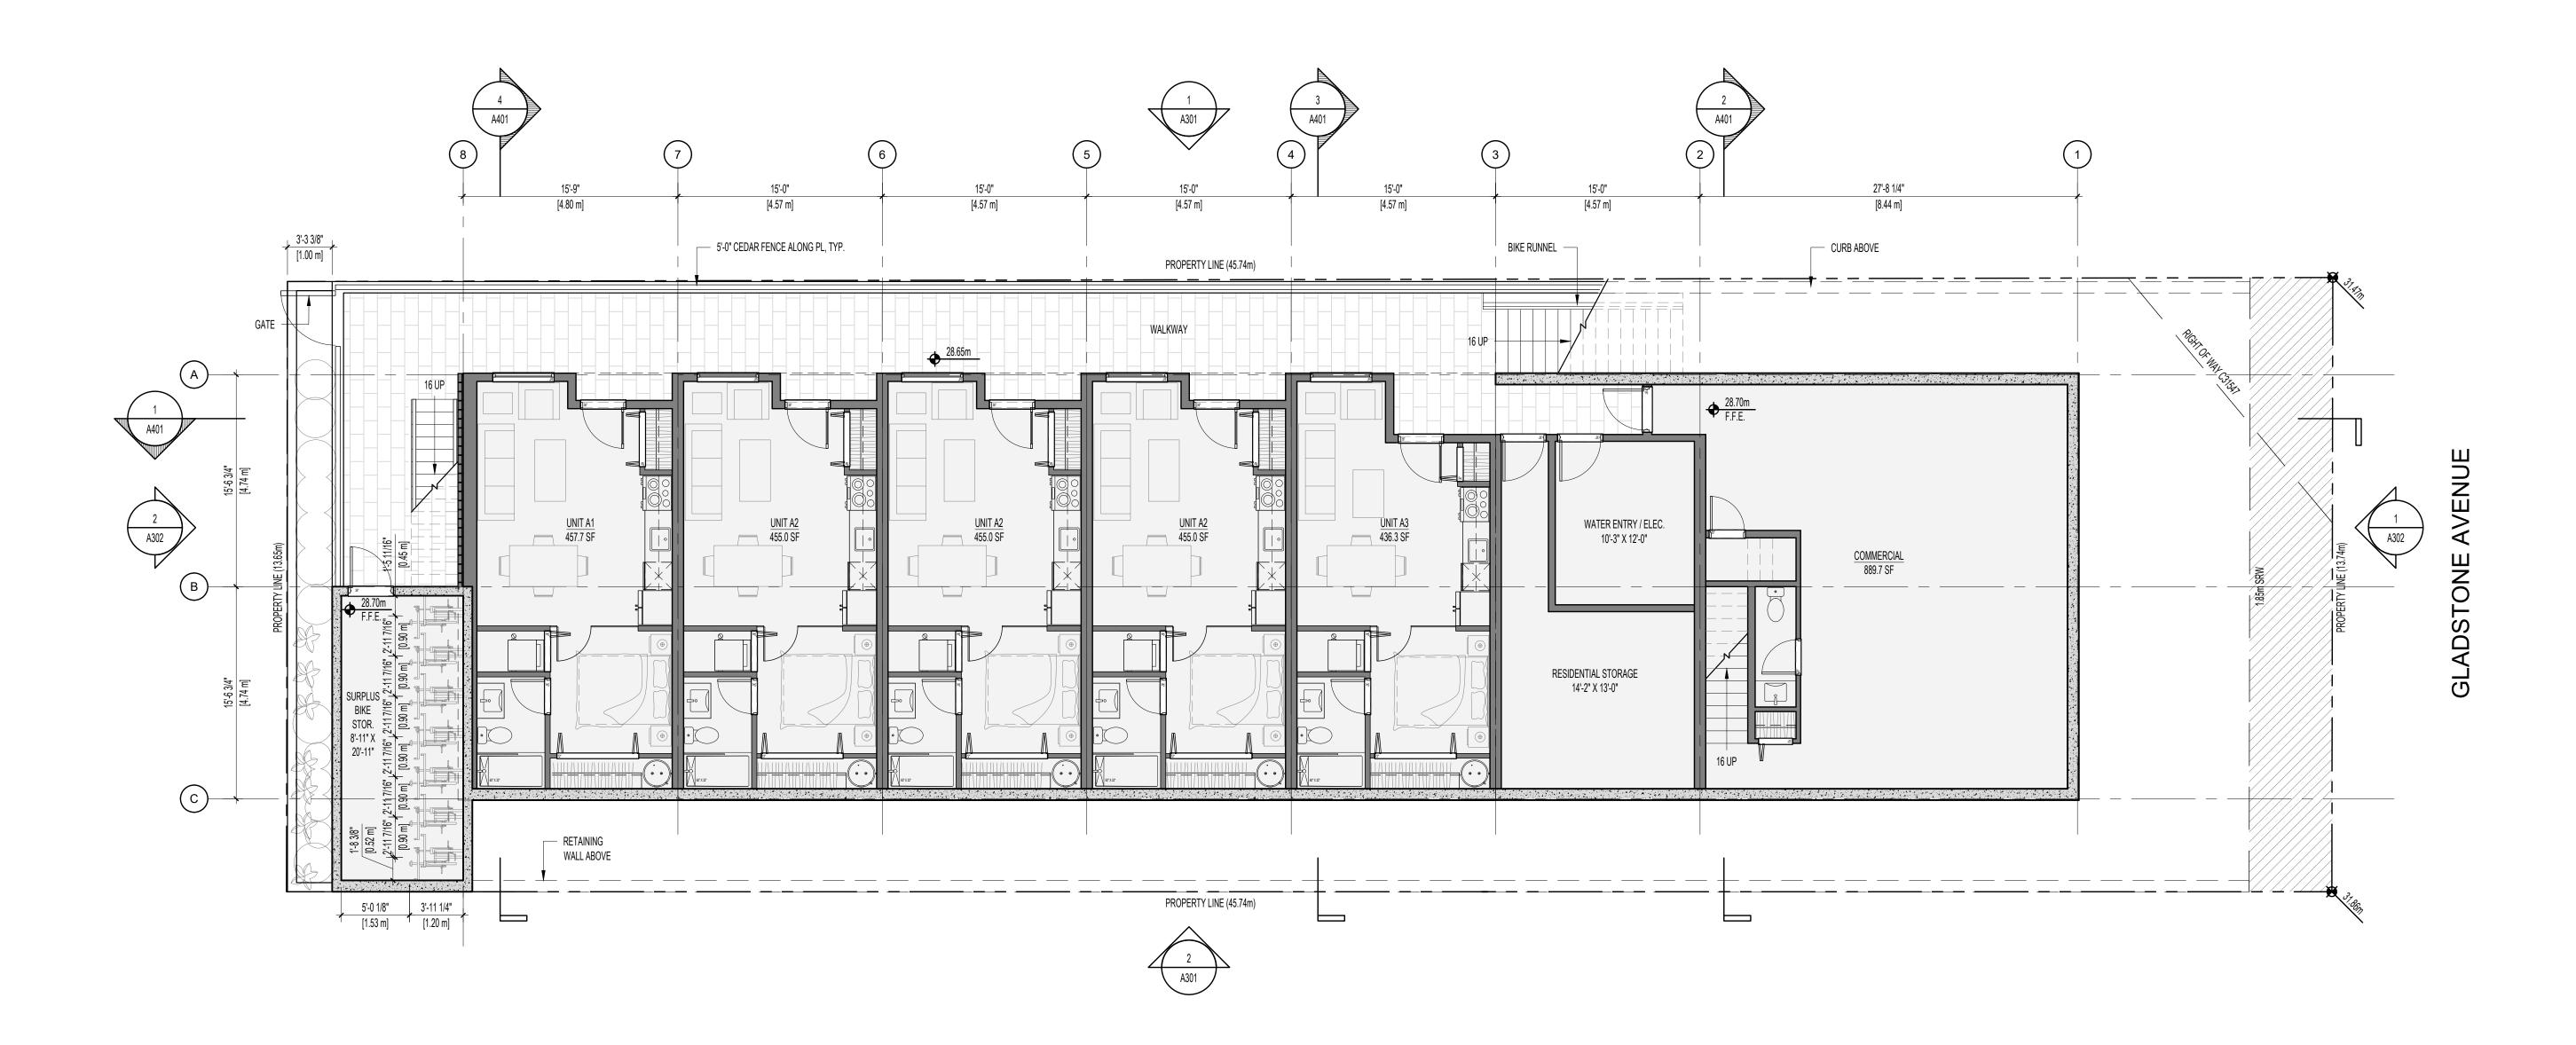
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PROPOSED SITE PLAN

DRAWING NO: A102





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PROJECT NAME

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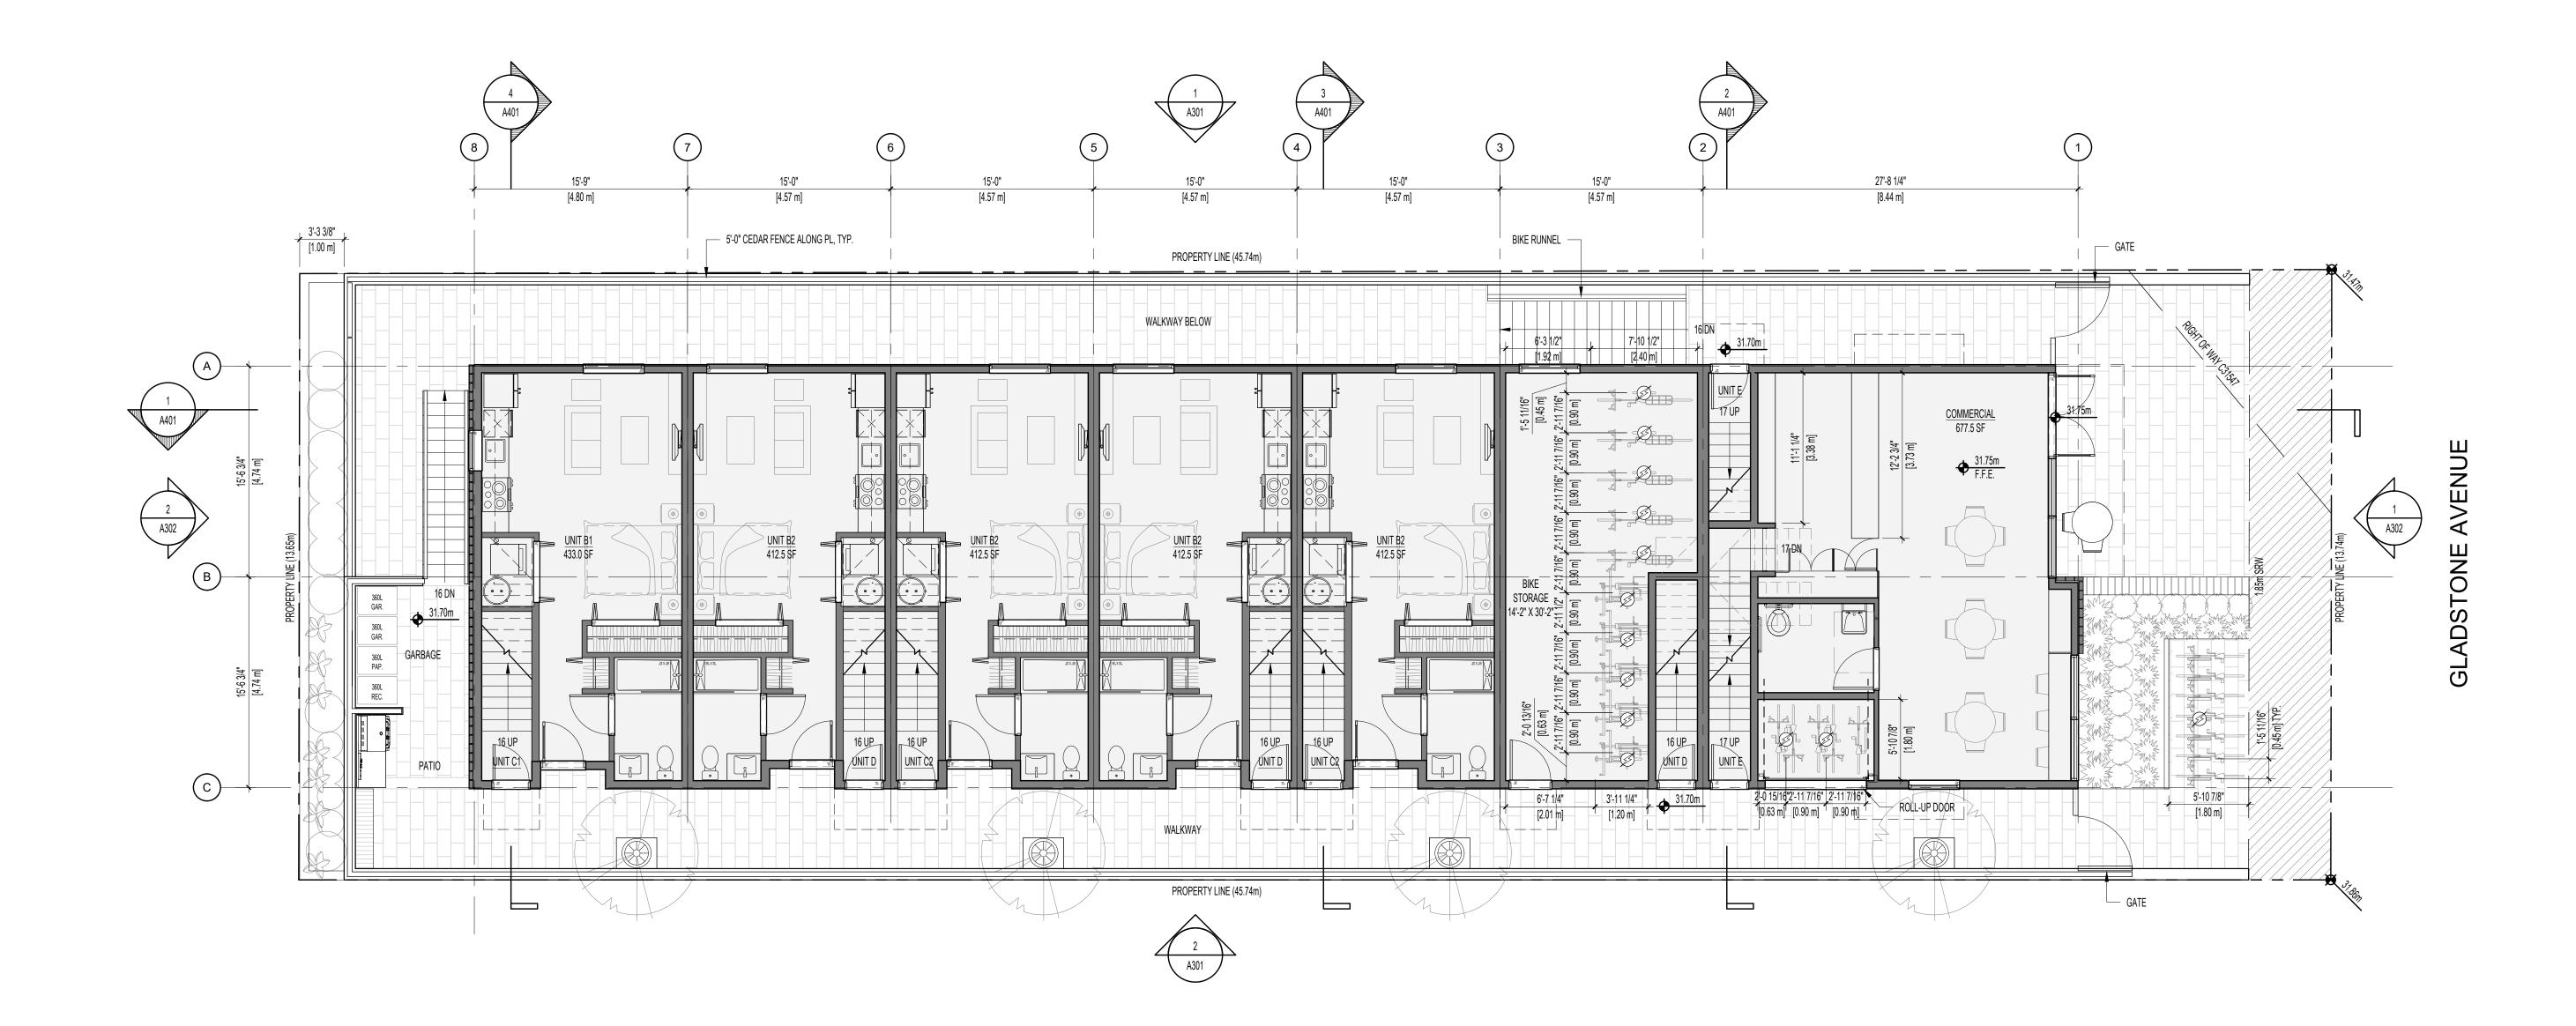
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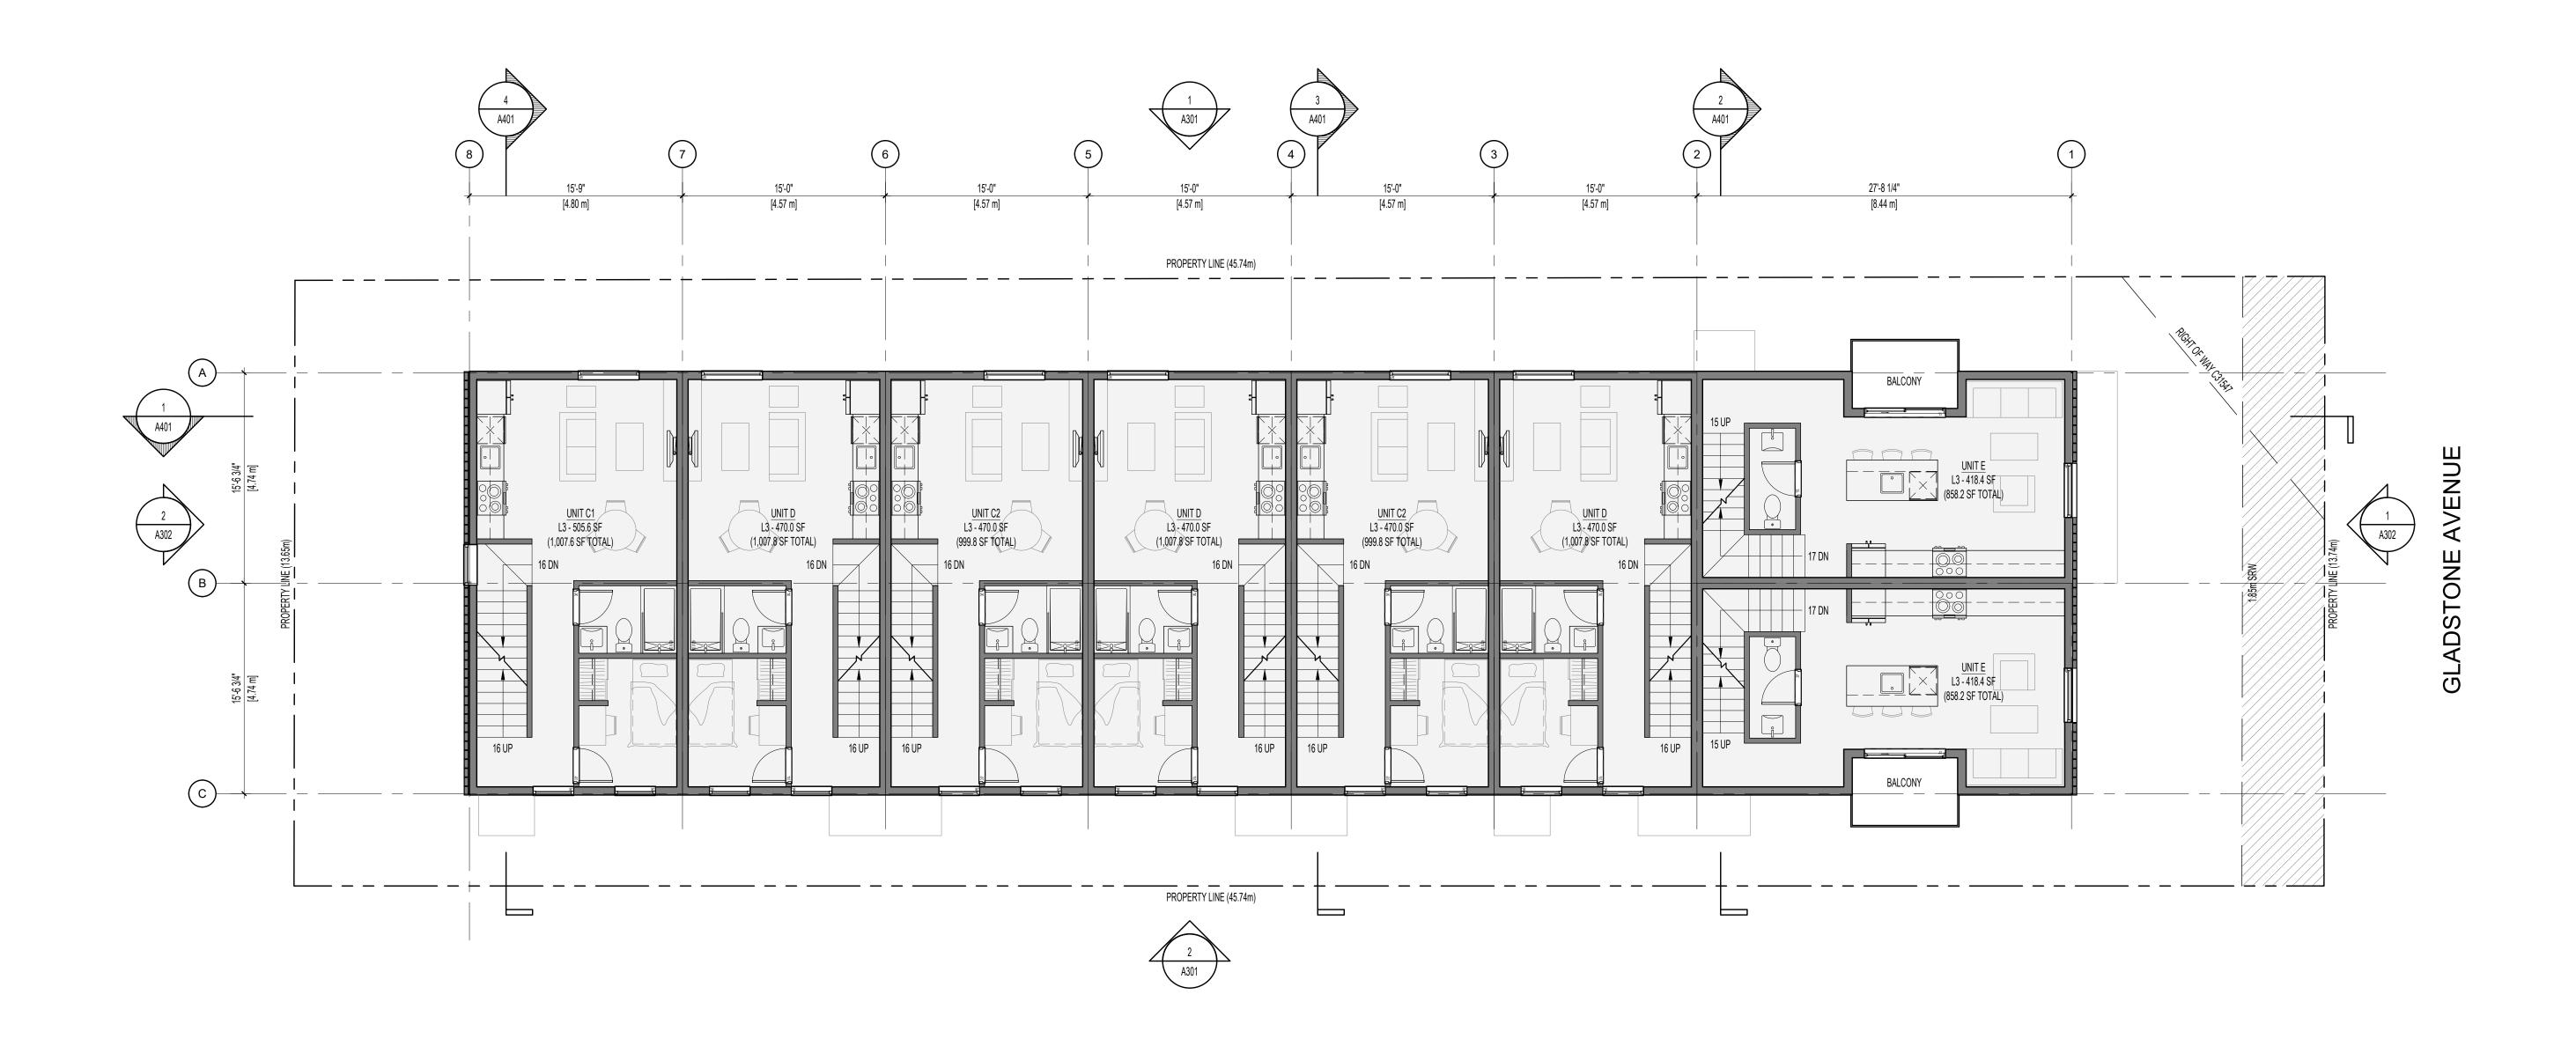
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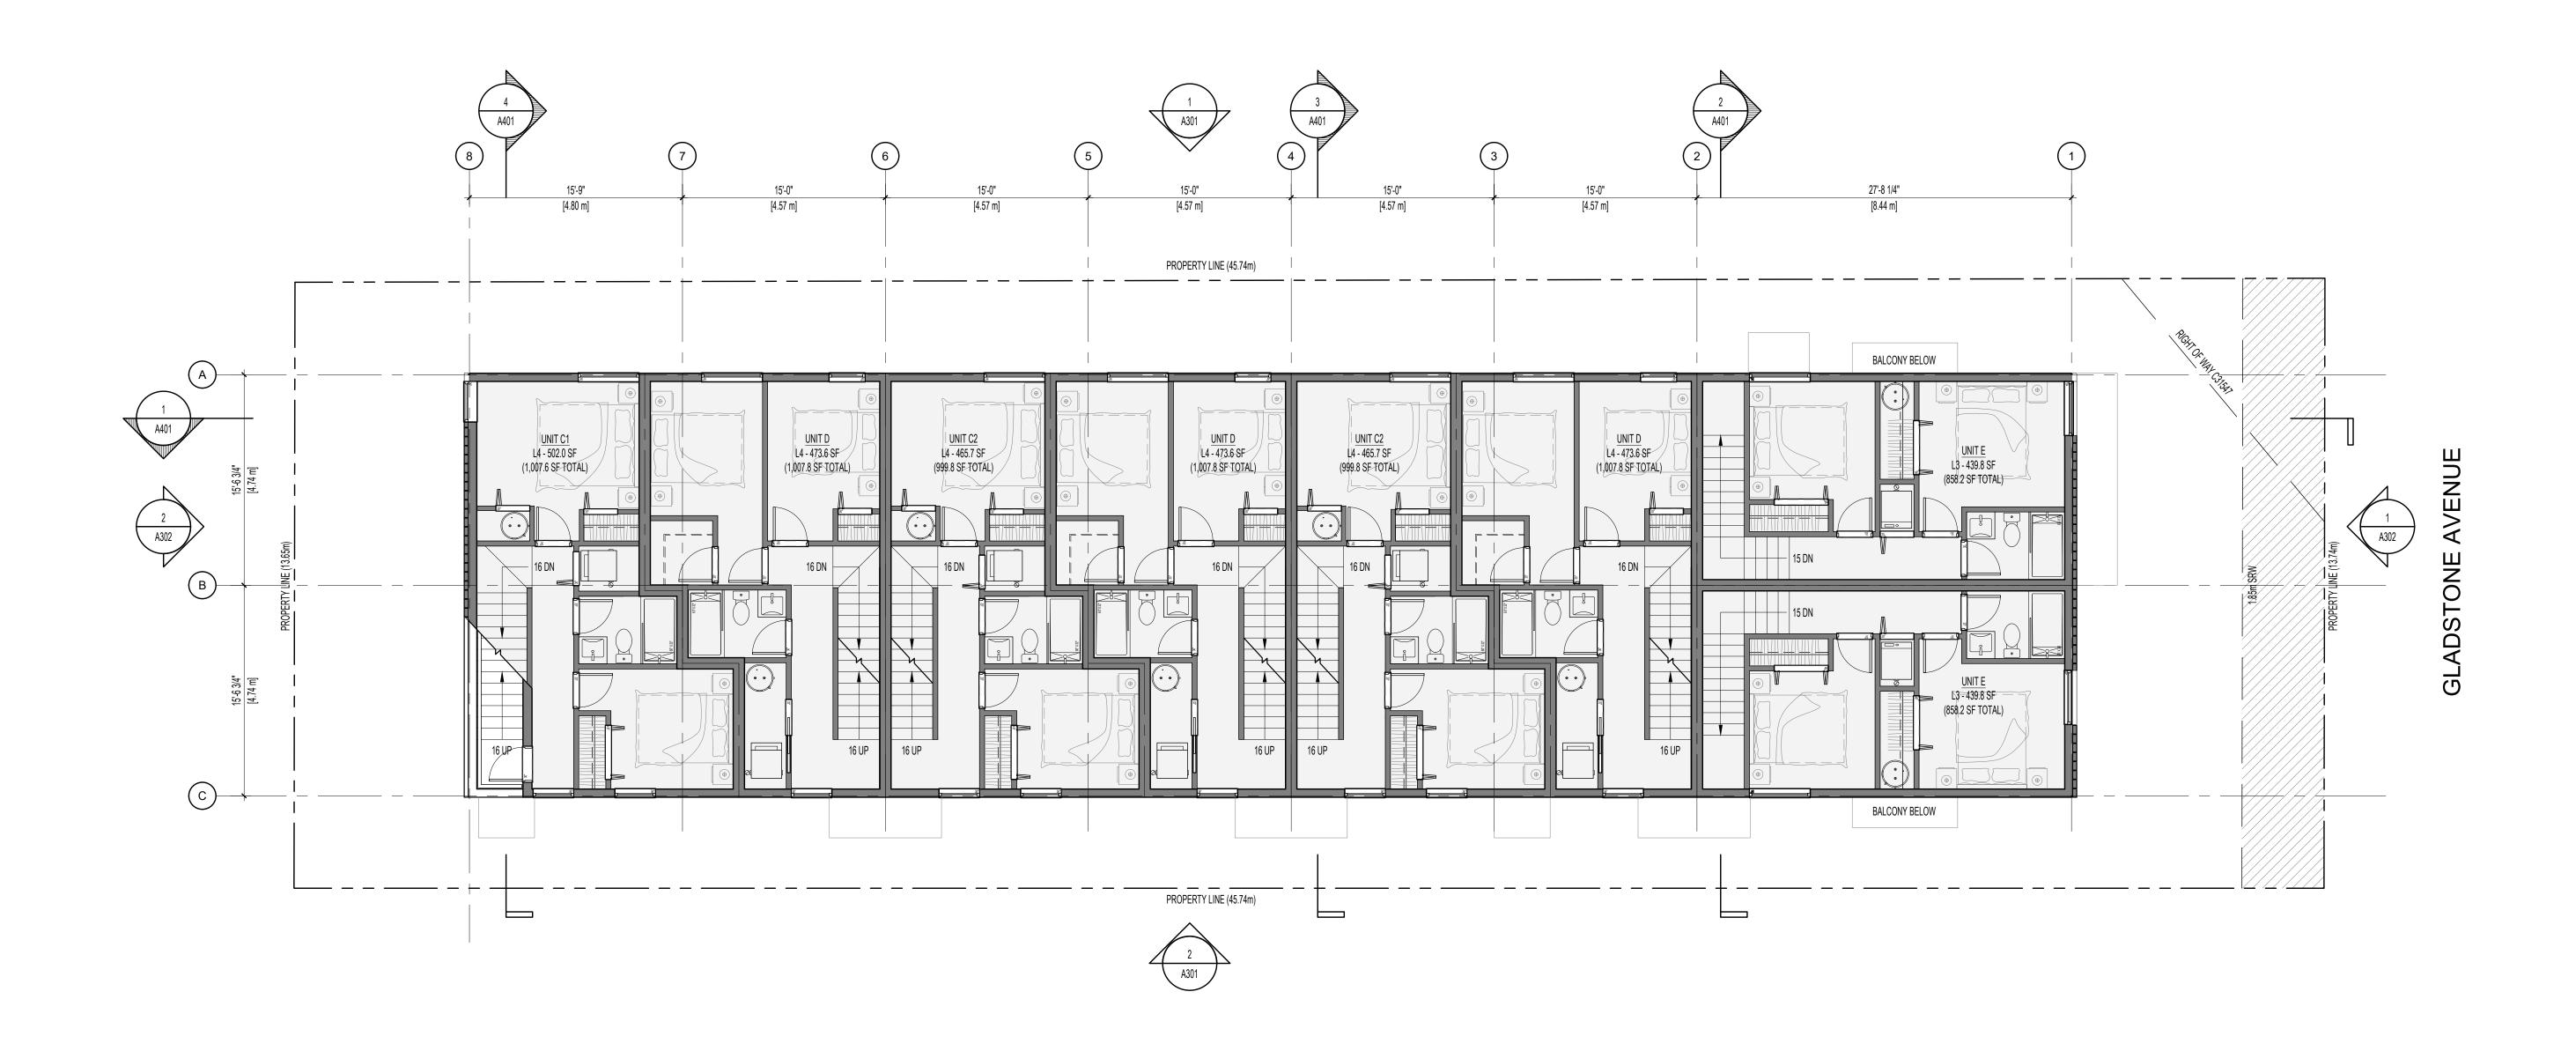
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PROJECT ADDRESS:


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02 ISSUED FOR REVIEW 11/03/2023

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ROOF PLAN

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 SCALE:
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 REVIEW BY:
 CH

 DRAWING NO:
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ELEVATIONS SHOWN AT BUILDING FACE.

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ISSUED FOR REVIEW	11/03/202

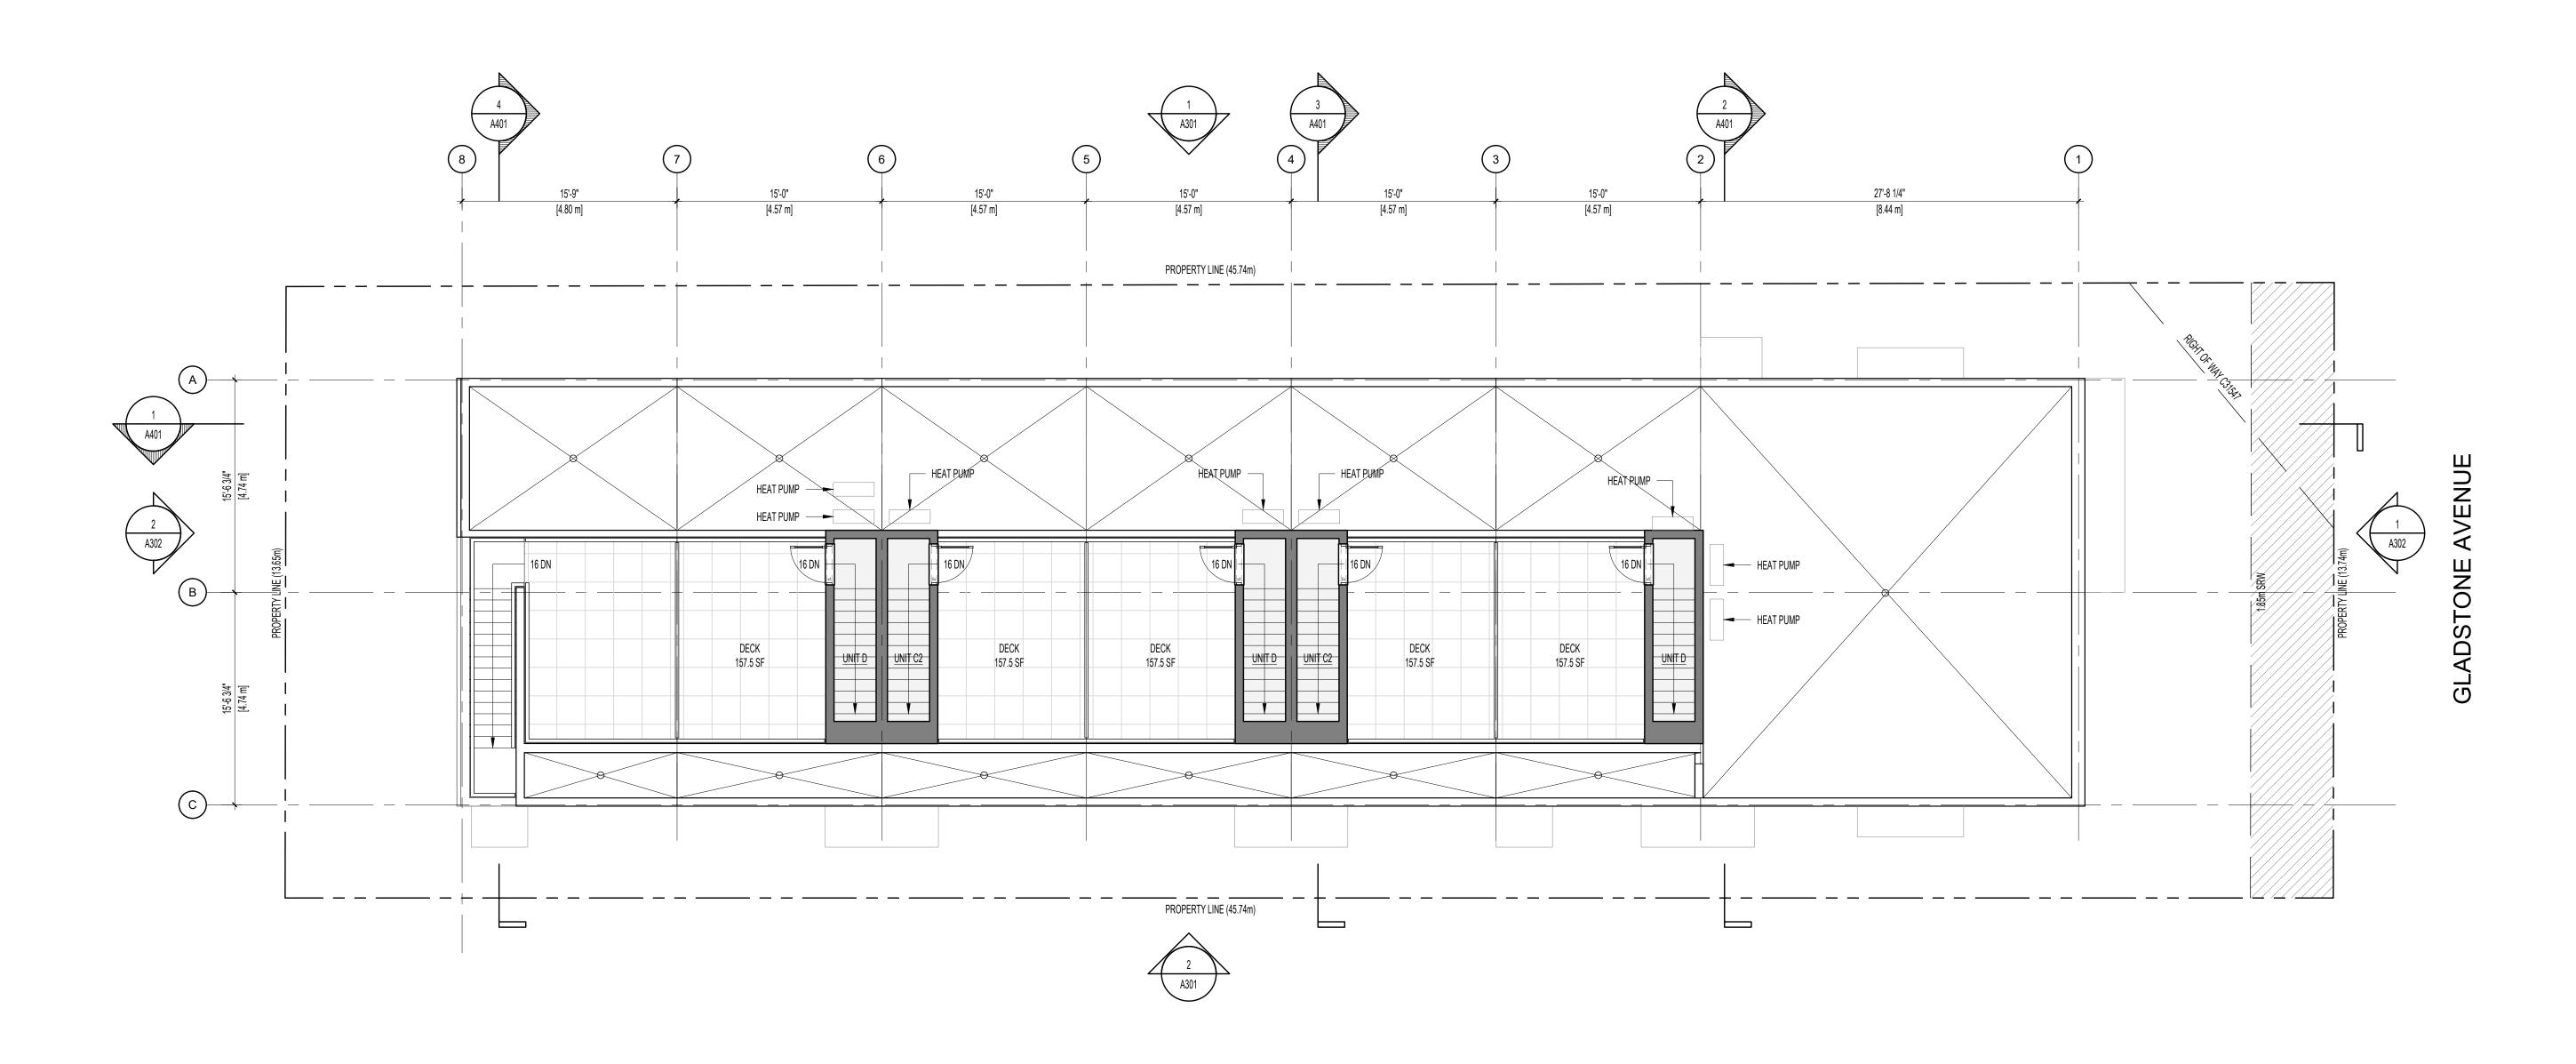 02
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 11/03/2023

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 REVIEW BY:
 CH

 DRAWING NO:
 A301





LEGEND MATERIAL RECLAIMED BRICK 2. VERTICAL STACK BOND BRICK 3. ARCHITECTURAL CONCRETE 4. FIBRE CEMENT BOARD & BATTEN SIDING BLACK FACTORY FINISH BLACK FACTORY FINISH BRAKE METAL FLASHING 6. STOREFRONT GLAZING BLACK FACTORY FINISH . ALUMINUM FLANGE WINDOW BLACK FACTORY FINISH 8. WALL-MOUNTED SCONCE LIGHTING BLACK FACTORY FINISH 9. WOOD DOOR BLACK FACTORY FINISH 10. YELLOW CEDAR T&G SIDING CLEAR STAIN 11. OPAQUE PRIVACY SCREEN 12. METAL PICKET GUARDRAIL BLACK POWDER COAT BLACK POWDER COAT STEEL PLATE CANOPY 14. METAL SIGNAGE BLACK POWDER COAT 15. FABRICATED METAL STAIR BLACK POWDER COAT 16. STEEL U-RACK BLACK POWDER COAT 17. WOOD FENCE BLACK PAINT 18. PAVERS19. LANDSCAPING GREY

PER LANDSCAPE

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2023-12-11

NORTH ARROW

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OWNER/CLIENT: TONNY KIPTOO 1252 GLADSTONE AVE, VICTORIA, BC, V8T 1G6

REISSUED FOR REZONING AND DEVELOPMENT PERMIT | 12/11/2023

ISSUED FOR REZONING AND DEVELOPMENT PERMIT 09/15/2023 PROJECT NAME

1276 GLADSTONE

VICTORIA, BC

PROJECT ADDRESS:

1276 GLADSTONE AVE. VICTORIA, BC, V8T 1G6




302-666 Cook Street, Victoria, BC, V8V 3Y7 778-584-0582 | info@charch.ca | charch.ca

ELEVATIONS

REVIEW BY: 1:75 DRAWING NO: A302



MATERIAL KEY

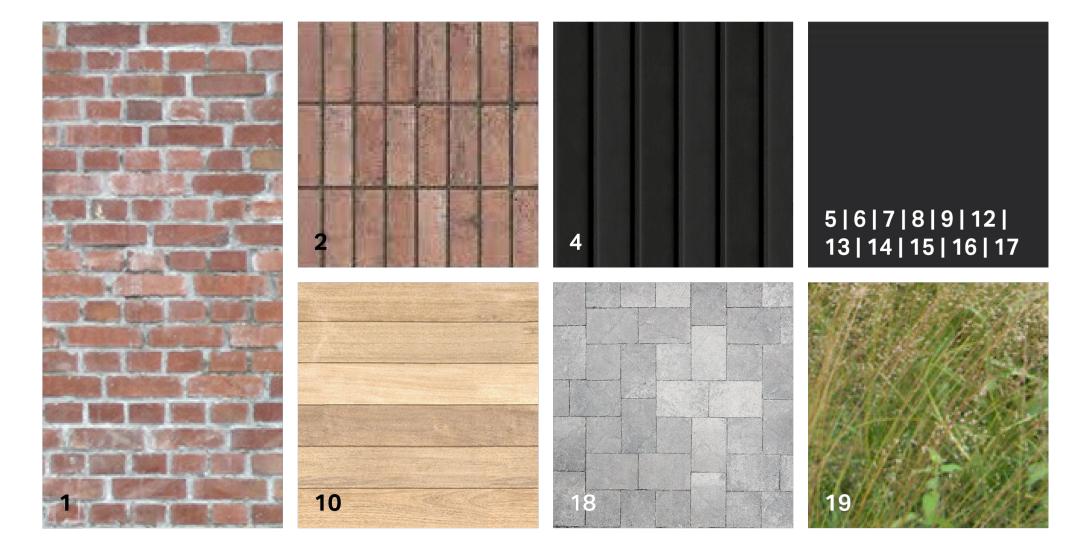


LEGEND MATERIAL RECLAIMED BRICK VERTICAL STACK BOND BRICK ARCHITECTURAL CONCRETE FIBRE CEMENT BOARD & BATTEN SIDING BLACK FACTORY FINISH BRAKE METAL FLASHING BLACK FACTORY FINISH STOREFRONT GLAZING ALUMINUM FLANGE WINDOW WALL-MOUNTED SCONCE LIGHTING WOOD DOOR YELLOW CEDAR T&G SIDING OPAQUE PRIVACY SCREEN 12. METAL PICKET GUARDRAIL13. STEEL PLATE CANOPY 14. METAL SIGNAGE
15. FABRICATED METAL STAIR
16. STEEL U-RACK
17. WOODENCE
18. PAVERS 19. LANDSCAPING

BLACK FACTORY FINISH BLACK FACTORY FINISH BLACK FACTORY FINISH CLEAR STAIN BLACK POWDER COAT BLACK PAINT GREY PER LANDSCAPE

MATERIAL BOARD

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OWNER/CLIENT: TONNY KIPTOO 1252 GLADSTONE AVE, VICTORIA, BC, V8T 1G6

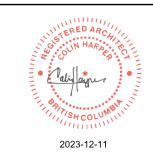REISSUED FOR REZONING AND DEVELOPMENT PERMIT | 12/11/2023 ISSUED FOR REZONING AND DEVELOPMENT PERMIT 09/15/2023 PROJECT NAME

1276 GLADSTONE VICTORIA, BC

PROJECT ADDRESS:

1276 GLADSTONE AVE. VICTORIA, BC, V8T 1G6



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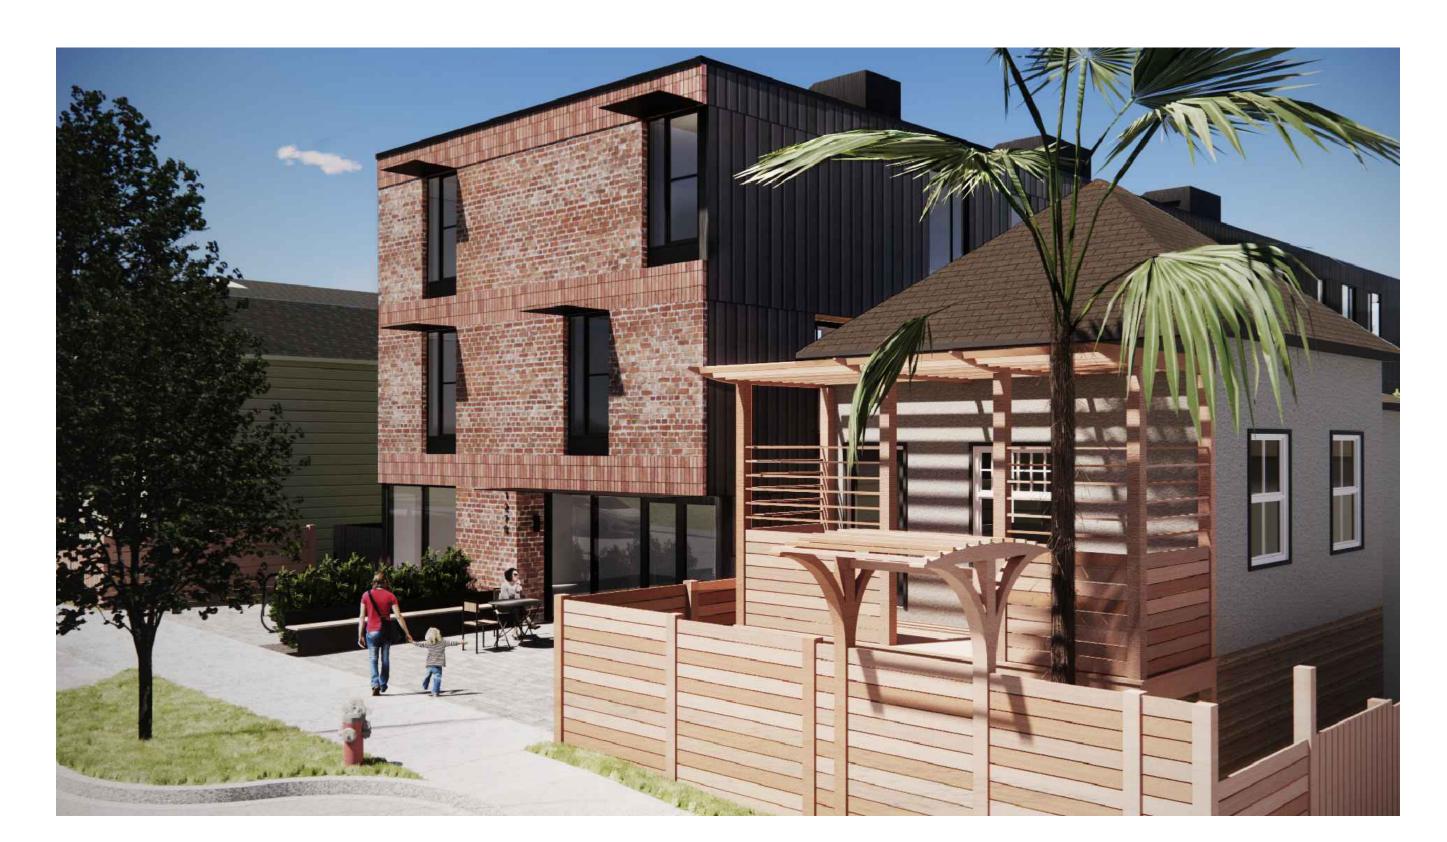
MATERIAL BOARD

			V 202
SCALE:	N/A	REVIEW BY:	СН
PROJECT NO:	2303	DRAWN BY:	KG

DRAWING NO: A303



1 SOUTHWEST CORNER



3 SOUTHEAST CORNER



PRONT ELEVATION



4 REAR YARD ELEVATION

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SEAL



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OWNER/CLIENT: TONNY KIPTOO 1252 GLADSTONE AVE, VICTORIA, BC, V8T 1G6

03	REISSUED FOR REZONING AND DEVELOPMENT PERMIT	12/11/2
02	ISSUED FOR REVIEW	11/03/2
01	ISSUED FOR REZONING AND DEVELOPMENT PERMIT	09/15/2

1276 GLADSTONE VICTORIA, BC

PROJECT ADDRESS:

PROJECT NAME


1276 GLADSTONE AVE. VICTORIA, BC, V8T 1G6




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RENDERINGS

		DPAWING NO:	A30
SCALE:	N/A	REVIEW BY:	СН
PROJECT NO:	2303	DRAWN BY:	KG



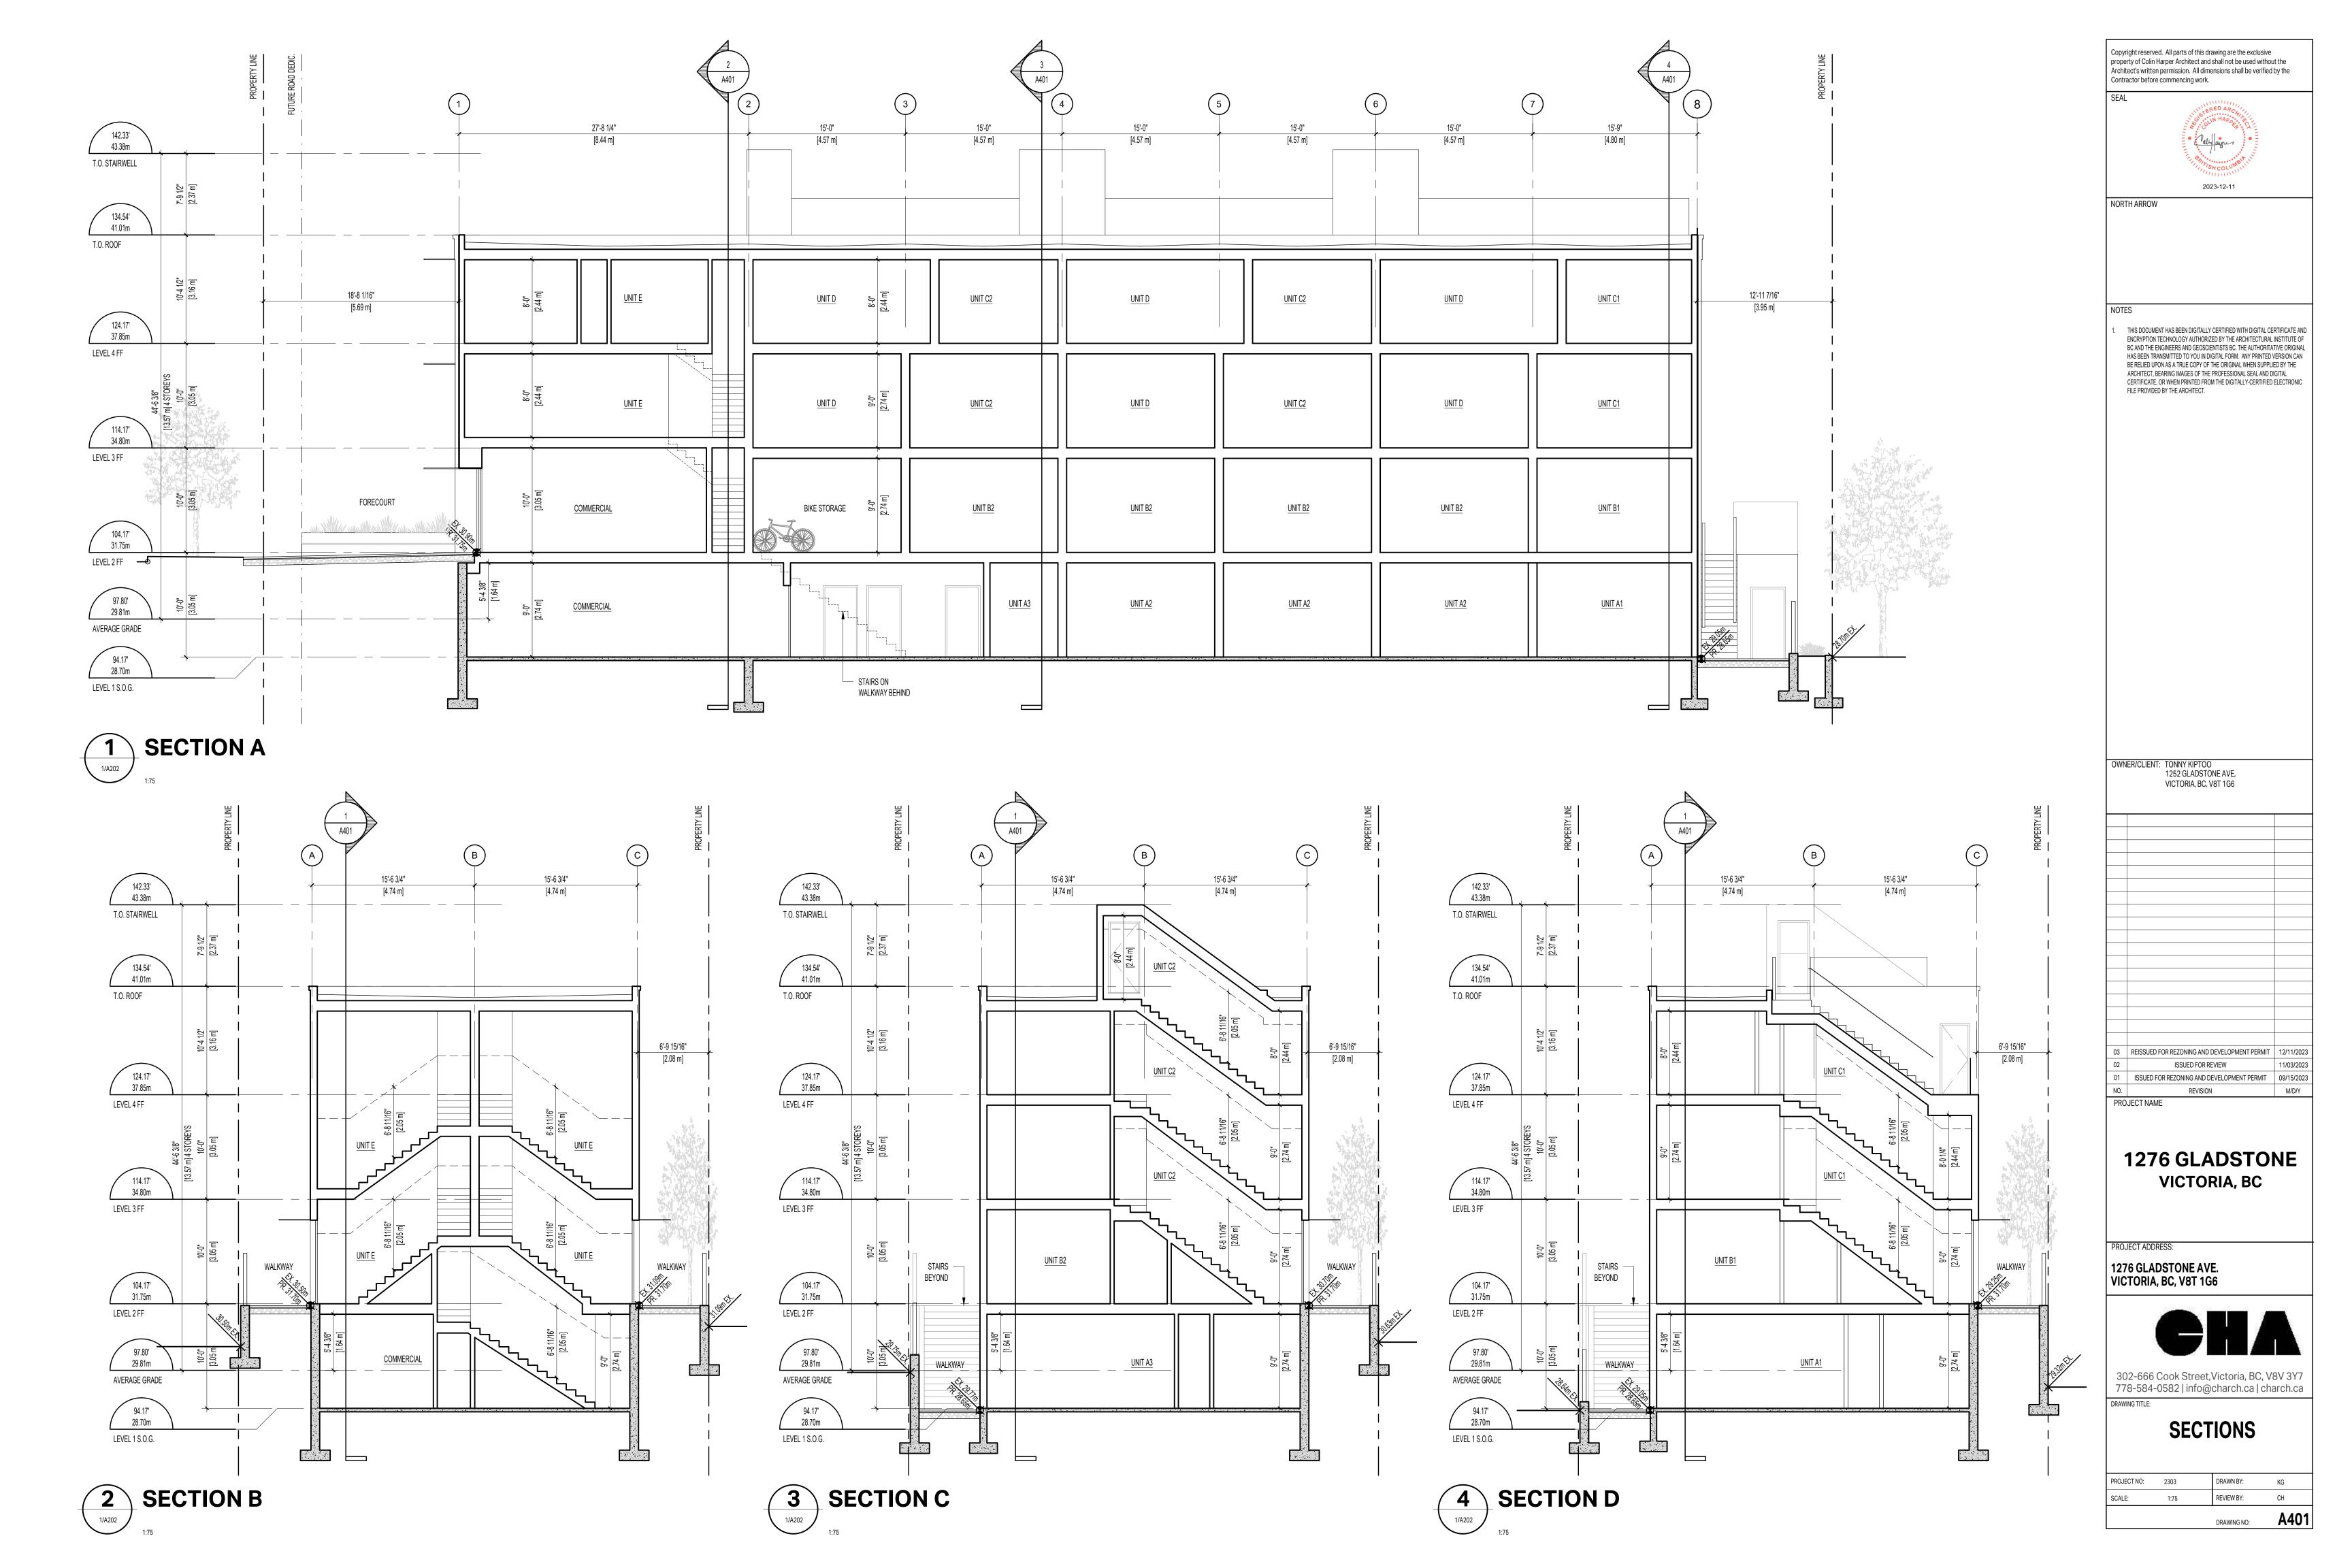

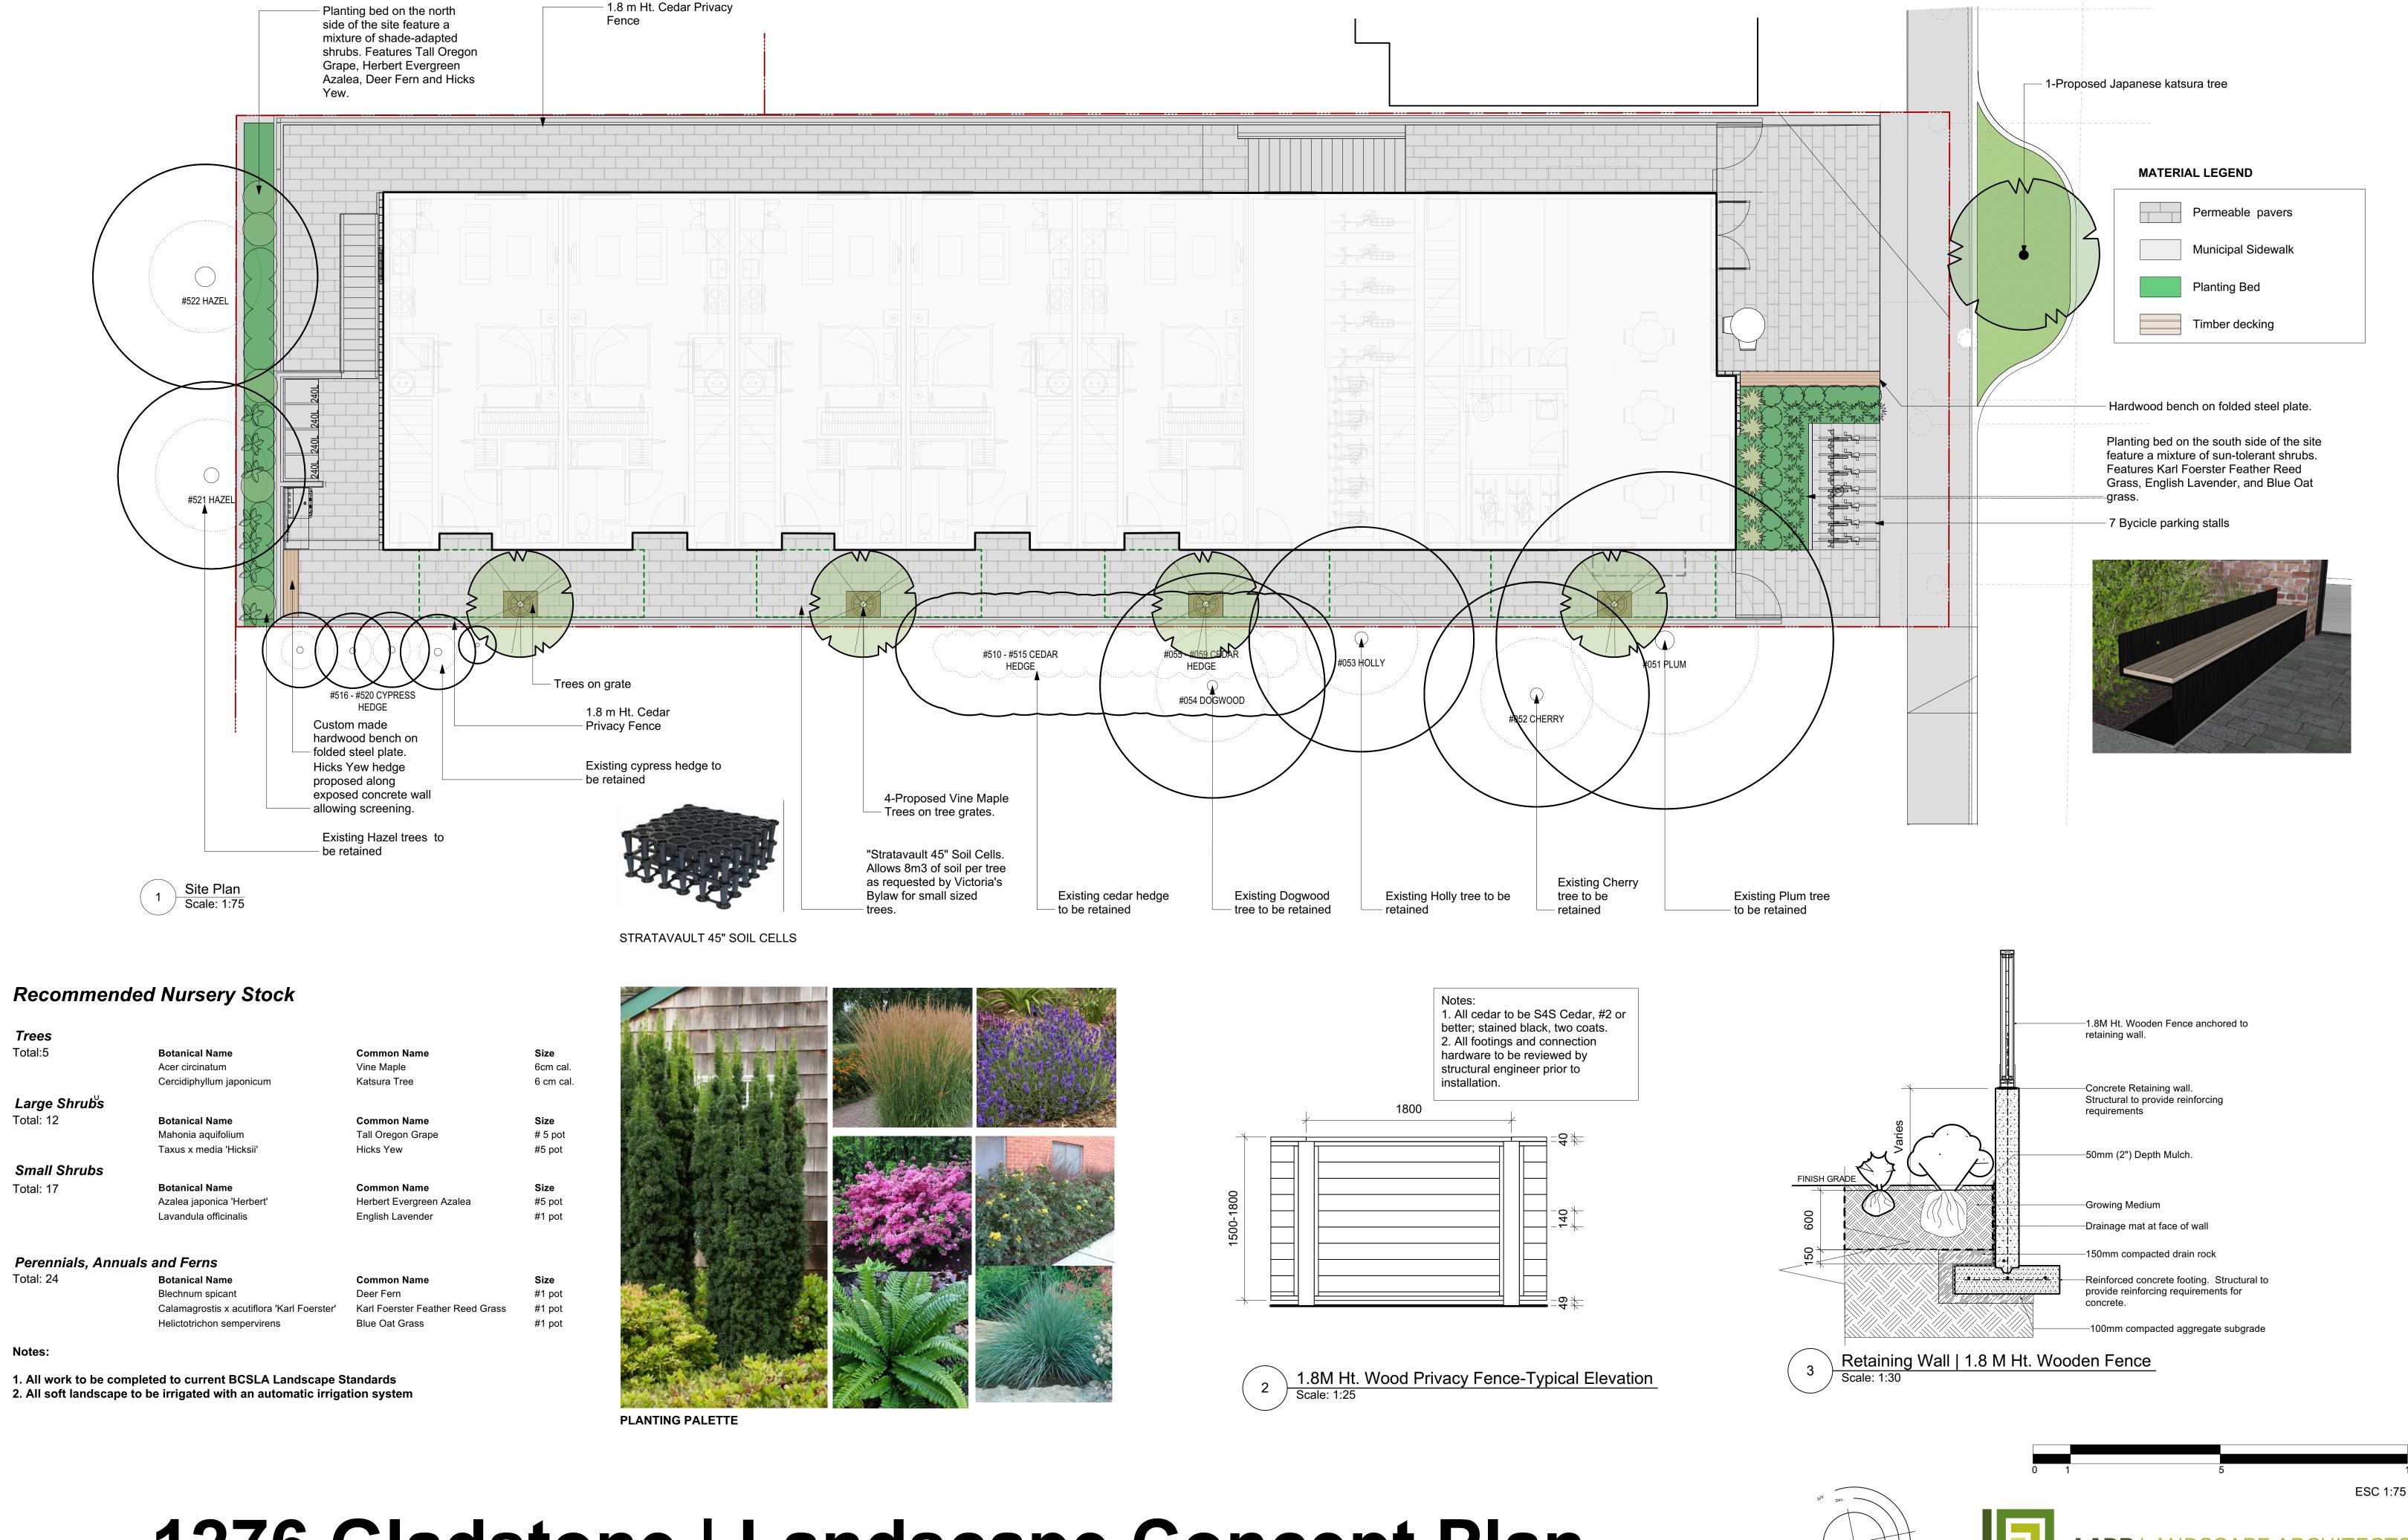Trees


Total: 17

Total:5





Phone: (250) 598-0105

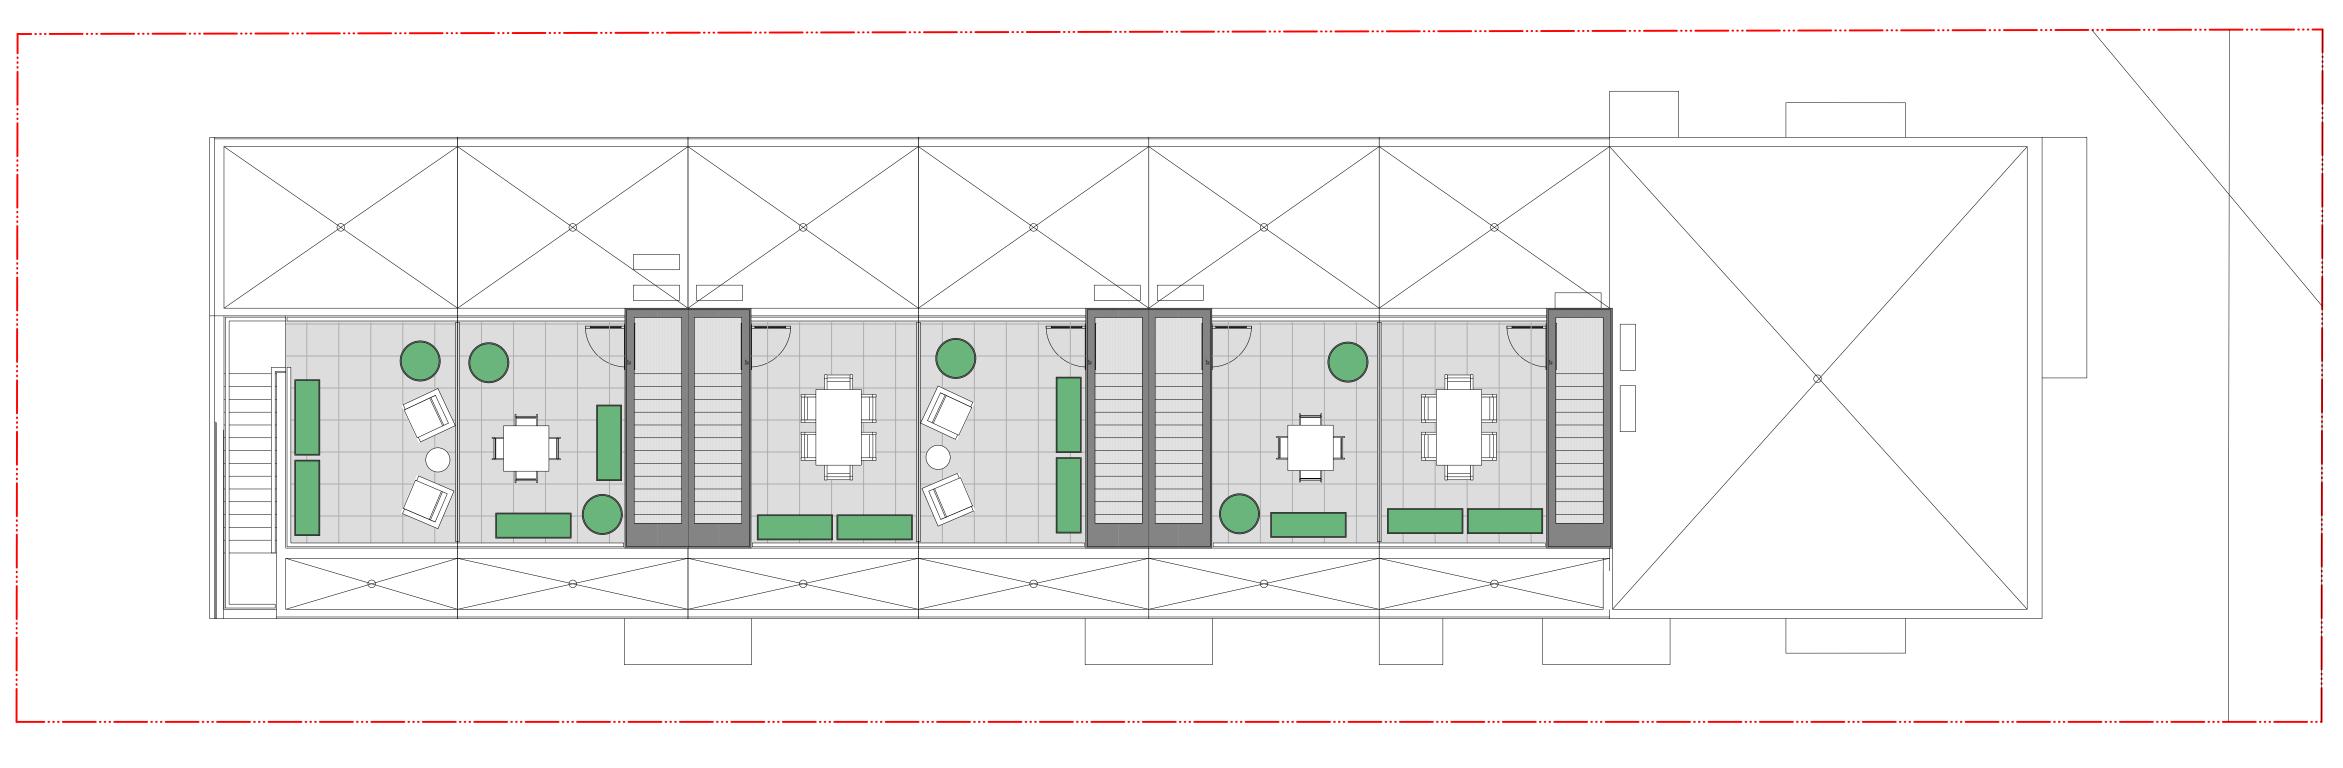

Permeable pavers

Municipal Sidewalk


Planting Bed

Timber decking


24" x 24" Pedestal pavers

NOTES:
-ROOFTOP LAYOUT FOR CONCEPTUAL PURPOSES.
-OWNERS TO SUPPLY FURNITURE AND PLANTERS

2 Rooftop Scale: 1:75

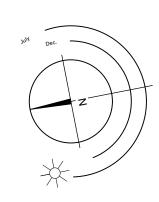



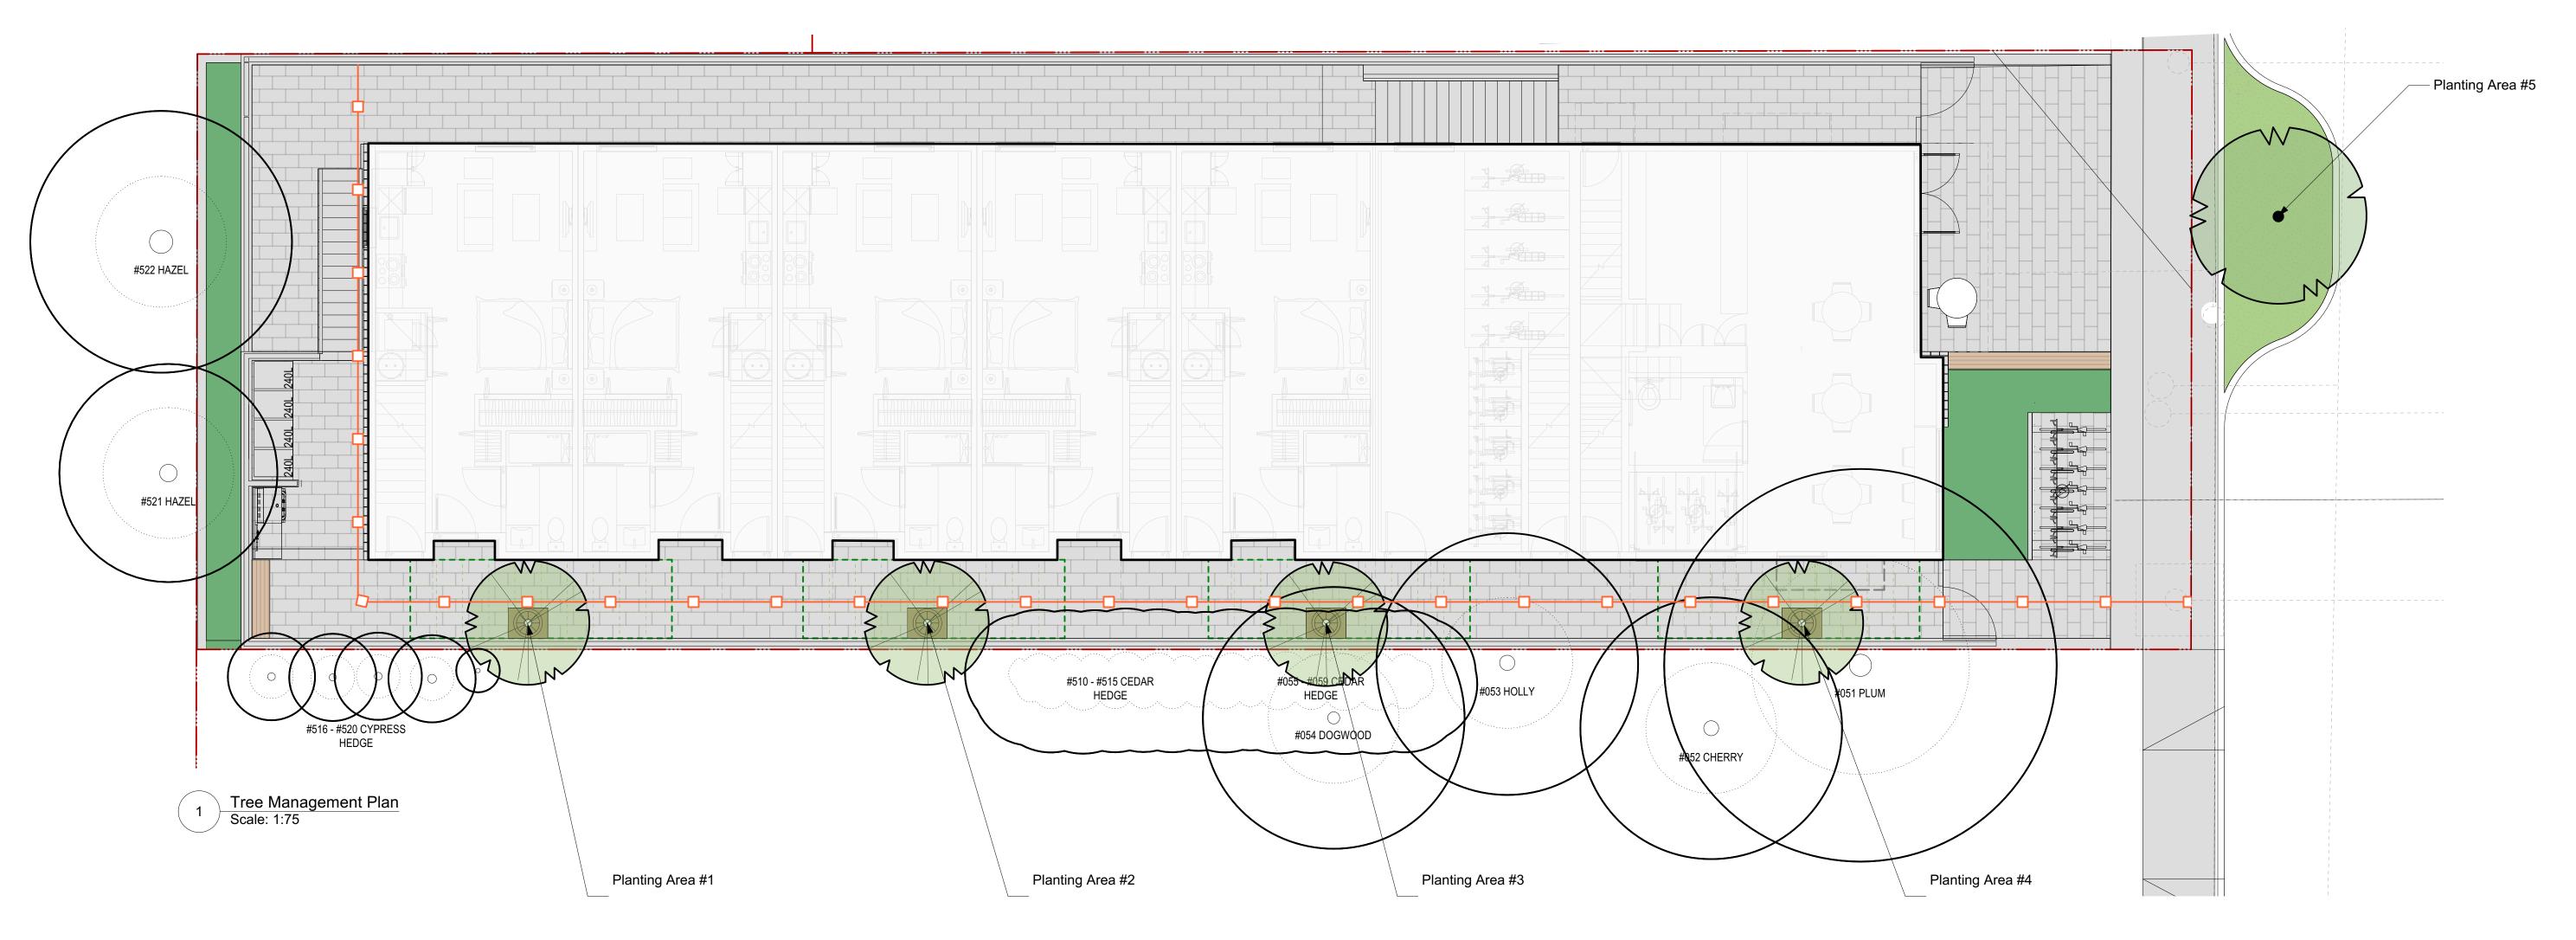

Existing Tree Legend:

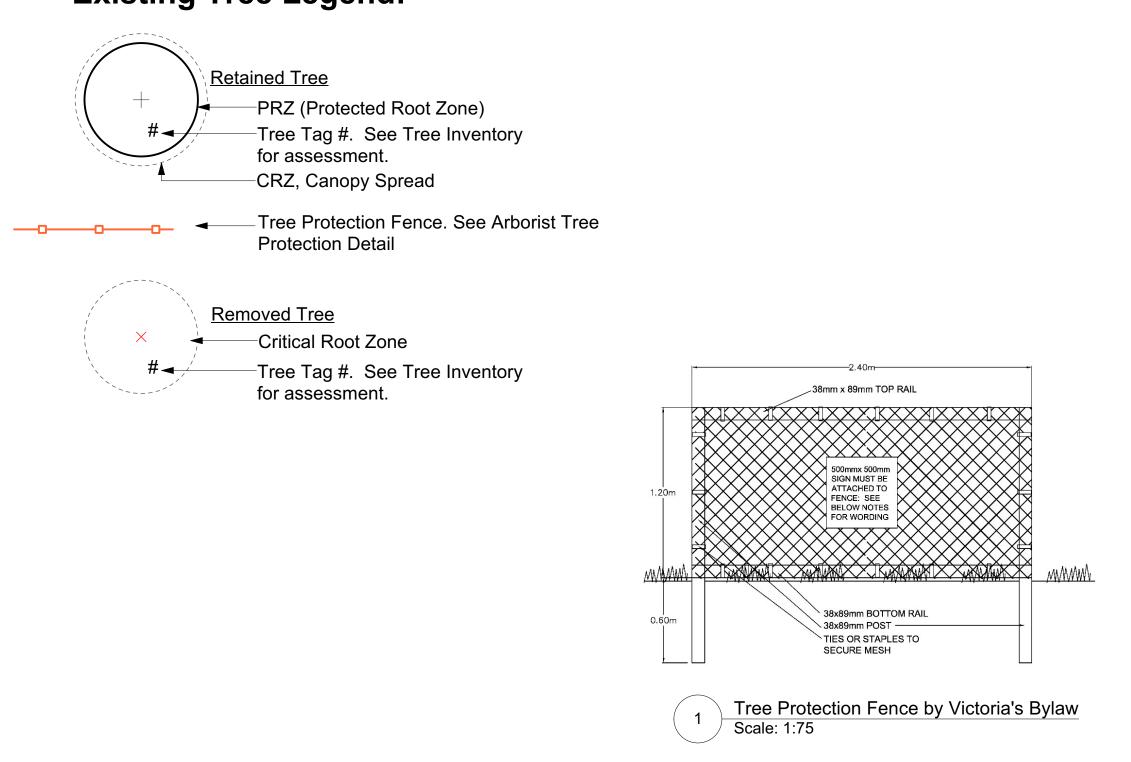


Figure #1 - Tree Inventory - Proposed Impact Area


Tag #	Spec.	DBH (cm)	Ht (M)	PRZ (M)	CRZ (M)	Health P/F/G	Structure P/F/G	Impact L/M/H	Tolerance L/M/H	Bylaw Prot.	Retain	Position	Comments
051	Pl Plum	50	7	9	5	F	Р	L/M	М	Bylaw	Х	Off site	Positioned approximately 2.5m off building setback
052	Cherry	34	8	6	3	F	Р	L	М	Bylaw	Х	Off Site	Positioned approximately 3.25m off building setback
053	Holly	35	7	6	3	F	F	L	М	Bylaw	Х	Off site	Positioned approximately 3.0 m off building setback
054	K Dogwood	28	8	6	3	F	F	L	М	Non- Bylaw	Х	Off site	Positioned approximately 3.0 m off building setback
055	E cedar	8	6	1	1	F	F	L/M	L	Non- Bylaw	Х	Off site	Hedge at P/L - 2m off building setback
056	E cedar	14	6	2	1	F	F	L/M	L	Non- Bylaw	Х	Off Site	Hedge at P/L - 2m off building setback
057	E cedar	10	6	1	1	F	F	L/M	L	Non- Bylaw	Х	Off Site	Hedge at P/L - 2m off building setback
058	E cedar	7	6	1	1	F	F	L/M	L	Non- Bylaw	Х	Off Site	Hedge at P/L - 2m off building setback
059	E cedar	15	6	2	1	F	F	L/M	L	Non- Bylaw	Х	Off Site	Hedge at P/L - 2m off building setback
0510	E cedar	10	6	1	1	F	F	L/M	L	Non- Bylaw	Х	Off site	Hedge at P/L - 2m off building setback
0511	E cedar	10	4	1	1	F	F	L/M	L	Non- Bylaw	Х	Off site	Hedge at P/L - 2m off building setback
0512	E cedar	12	6	1	1	F	F	L/M	L	Non- Bylaw	Х	Off site	Hedge at P/L - 2m off building setback
0513	E cedar	20	6	2	1	F	F	L/M	L	Non- Bylaw	Х	Off site	Hedge at P/L - 2m off building setback
0514	E cedar	10	5	1	1	F	F	L/M	L	Non- Bylaw	Х	Off site	Hedge at P/L - 2m off building setback
0515	E cedar	10	6	1	1	F	F	L/M	L	Non- Bylaw	Х	Off site	Hedge at P/L - 2m off building setback
0516	cypress	10	7	1	1	F	P	L/M	M	Non- Bylaw Non-	X	Off site	Hedge formation
0517	cypress	20	7	2	1	F F	P P	L/M L/M	M M	Bylaw Non-	X	Off site	Hedge formation Hedge formation
0518	cypress	16	7	2	1	F	P	L/M	M	Bylaw Non-	X	Off site	Hedge formation
0520	cypress	19	7	2	1	F	P	L/M	M	Bylaw Non-	X	Off site	Hedge formation
0521	Hazel	40	6	5	3	F	P	L/M	M	Bylaw Bylaw	Х	Off site	5 x stem, 13,15,13,12
0522	Hazel	53	6	6	3	F	P	L/M	M	Bylaw	X	Off site	& 12cm 4 x stem, 20,14,17 & 16cm

Figure #6 – Tree Planting Area Soil Volume Chart

Planting	Area (m2)	Soil	A. Est.	Replacement Tr	C.	D#	E.	F.	G.	Total
Area	11100 (1112)	Volume	Soil		#Medium	Large	small	Medium	Large	101111
		Multiplier	Volume							
				ONSITE						
Planting	8	1	9				9			9
Area 1										
Planting	8	1	9				9			9
Area 2										
Planting	8	1	9				9			9
area 3										
Planting	8	1	9				9			9
area 4	~ .	2.5	1.4				1.4			1.4
Planting	56	.25	14				14			14
Artea 5 BLVD										
DLVD				OFFSITE						
Dlantina				OFFSITE						
Planting Area										
OSA x										
ODITA				Calculations						
				Calculations			If B=1,	IF C=1,	If	E+F+G
							Bx8 if	CX20 if	D=1,	E+r+G
							B>1,	C>1,	D=1, Dx35	
							Bx6	Cx15	If	
							DAO	CAIS	D>1,	
									Dx30	

Project No: 2316 DEC-08-23



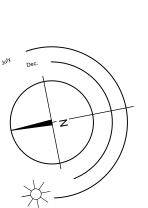




Phone: (250) 598-0105

- 1. PROPOSED 50mm DOMESTIC WATER LINE AND 100mm FIRE LINE TO BE INSTALLED GENERALLY CONFIGURED AS PER CITY OF VICTORIA (CoV) STD DRAWING SD W2f BY CITY FORCES AT DEVELOPER'S EXPENSE
- 2. Cov forces to install new 1500 pvc sewer service at Min. 2.0% to pl c/w inspection chamber inside approved conc. Box at developer's expense
- 3.) CoV FORCES TO INSTALL NEW 1500 PVC DRAIN SERVICE AT MIN. 2.0% TO PL c/w INSPECTION CHAMBER INSIDE APPROVED CONC. BOC AT DEVELOPER'S EXPENSE
- (4.) INSTALLED GAS SERVICE LOCATION AS PER FORTIS BC (3.41m E OF W PL)

<u>LEGEND</u>

- A XXX.Xm² LOT AREA
- G XXX.Xm APPROX. GROUND ELEVATION OF SERVICES AT PL
- S XXX.XXX SEWER SERVICE INVERT AT PL
 X+XXX.X DISTANCE FROM DOWNSTREAM SEWER MANHOLE
- D XXX.XXX DRAIN SERVICE INVERT AT PL
 X+XXX.X DISTANCE FROM DOWNSTREAM DRAIN MANHOLE
- CONCRE

CONCRETE SURFACE

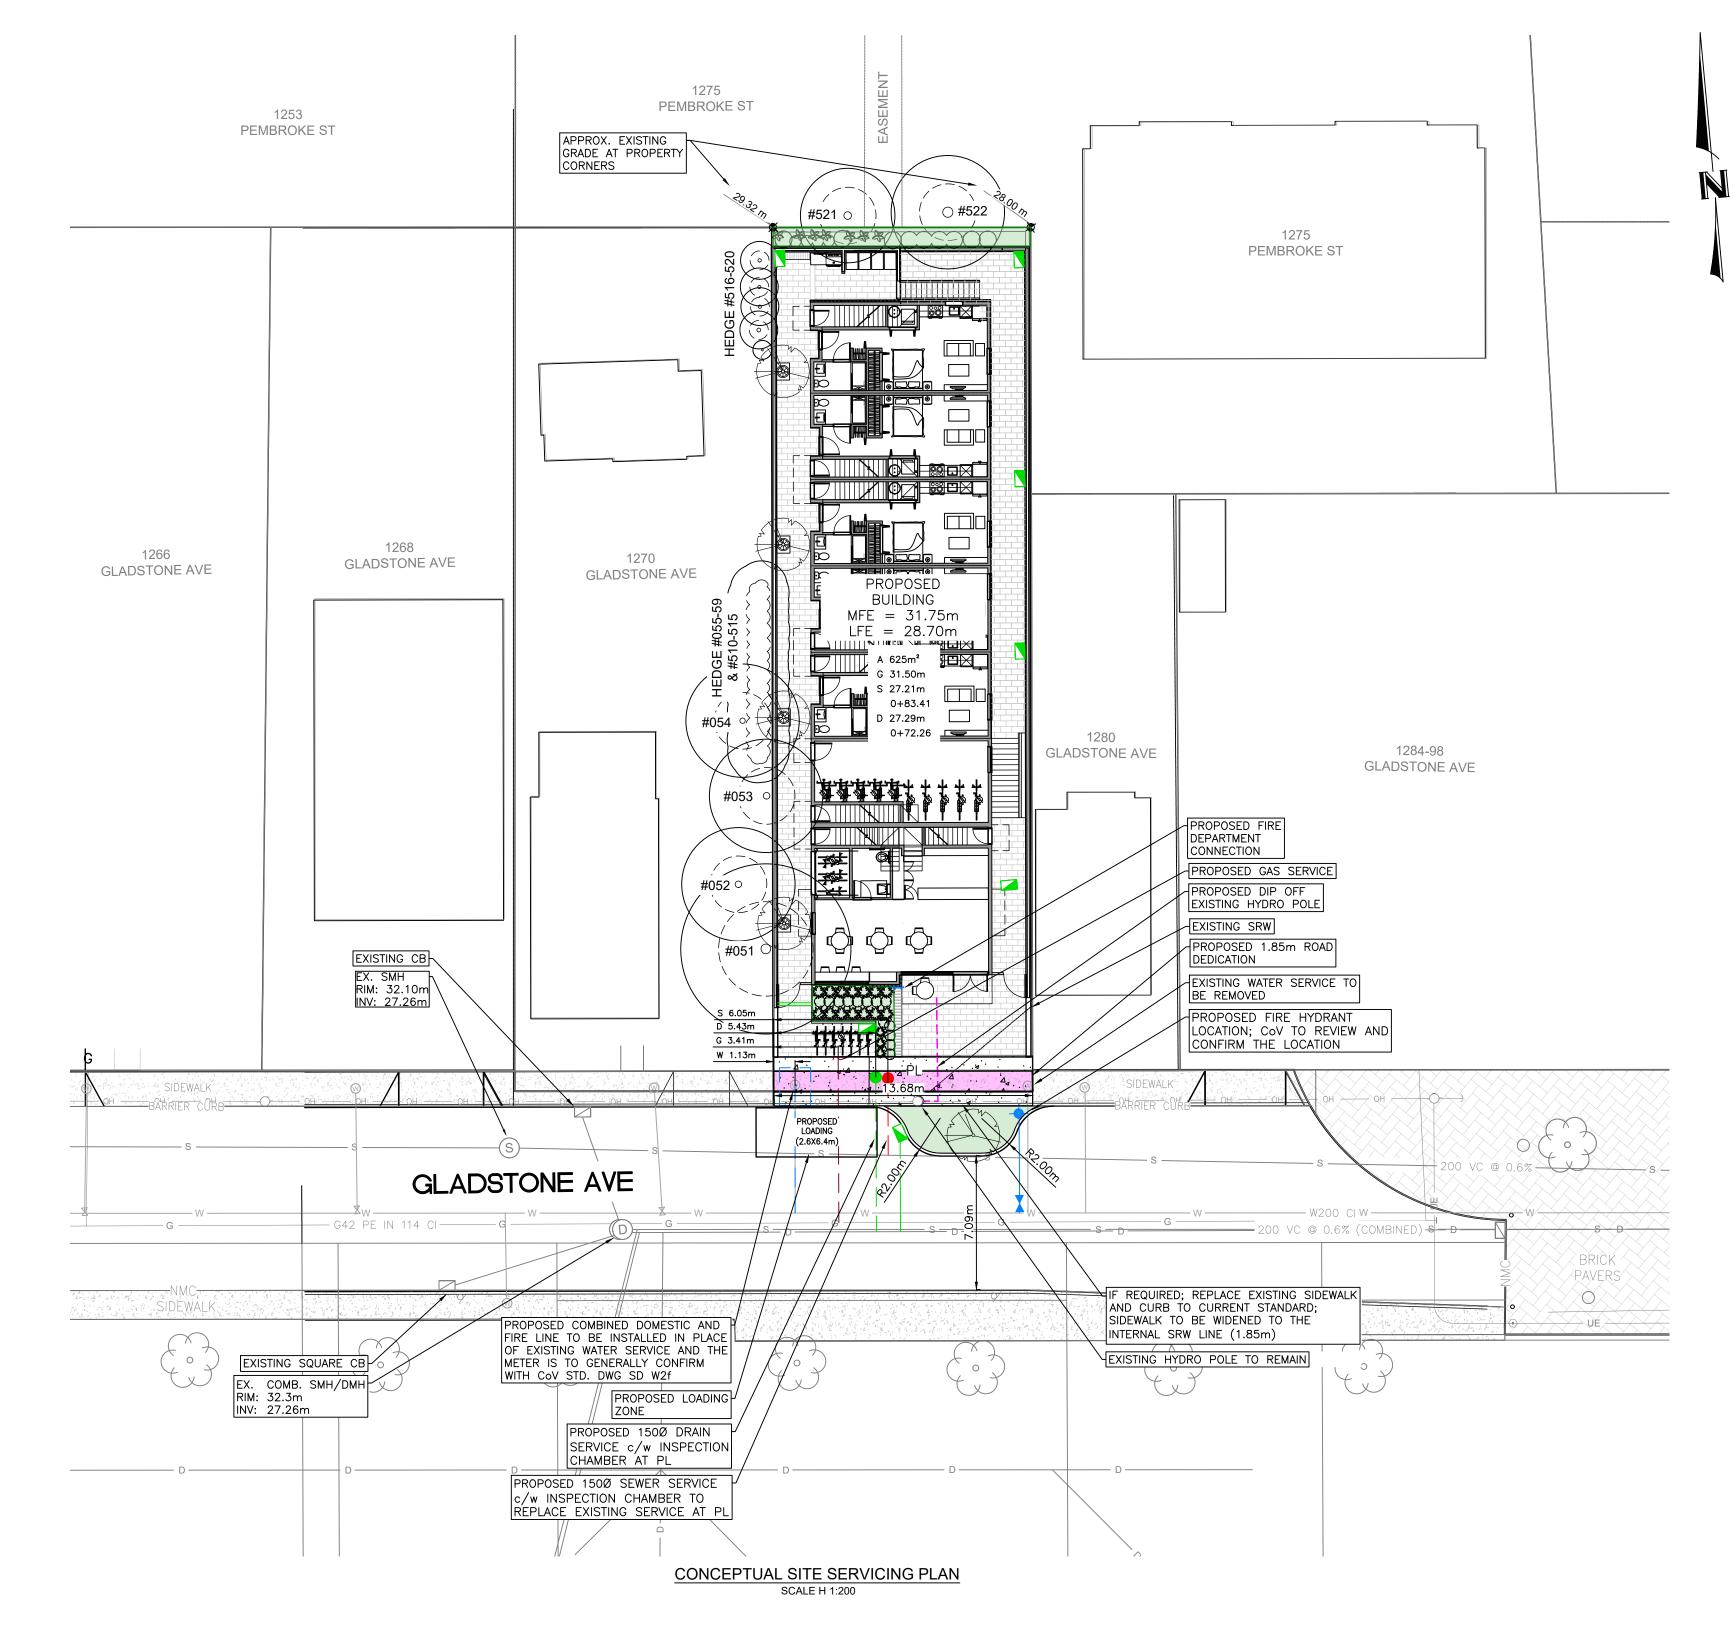

	WORKS AND SERVICES CHECK TABLE					
PLAN CHECKER -		AUTHORIZED RE	DATE			
	FLAN CHECKEN	NAME SIGNATURE		DATE		
	HYDRO					
۲	TELUS					
UTILITY	FORTIS BC					
	SHAW					
_	UNDERGROUND SERVICES					
.IPAI	STREETS					
MUNICIPAL	TRANSPORTATION					
Ĭ	LAND DEVELOPMENT					

1276 GLADESTONE MULTI FAMILY DEVELOPMENT


SERVICE SIZING SUMMARY

SERVICE SIZING SOMMARY					
1276 GLADSTONE AVENUE SITE AREA = 625m ² IMPERVIOUS AREA = 610.7m ²					
SANITARY	PROPOSED LOAD	SERVICE SIZE			
SERVICE	280FU 150mm SERVICE	840FU MAXIMUM LOAD FOR 150mm @ 2.0% (PLUMBING CODE)			
DRAIN					
SERVICE	AREA X 15min RAINFALL (PLUMBING CODE) 8.34 L/s	19.56 L/s MAXIMUM LOAD FOR 150mm @ 2.0% (PLUMBING CODE)			
WATER					
AWWA	542 FIXTURE VALUE 38mm METER c/w 50mm SERVICE	38mm METER NORMAL OPERATING RANGE 0.5 GPM to 200 GPM			

NOTE: ALL FIXTURE VALUES TO BE CONFIRMED BY THE PROJECT MECHANICAL ENGINEER AT THE BUILDING PERMIT STAGE

UNDERGROUND SERVICES INFORMATION				
INFORMATION IS AT PROPERTY LINE	STORM DRAIN	SANITARY SEWER		
PROPOSED DEPTH (m)	4.21m	4.29m		
PROPOSED INVERT ELEVATION (m)	27.29m	27.21m		
MAXIMUM DEPTH REQUESTED	☐ YES ☐ NO	☐ YES ☑ NO		

NOTE: NEW FIRE HYDRANT REQUIRED, CITY OF VICTORIA TO

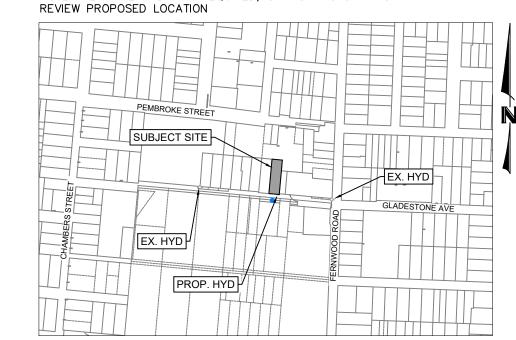

GENERAL LOCATION PLAN

LEGAL: LOT 2, SECTION 61, SPRING RIDGE, VICTORIA CITY PLAN 312 CIVIC: 1276 GLADESTONE AVENUE

SUBMITTED FOR REZONING /
DEVELOPMENT PERMIT

APPLICATION



ENGINEERING

623 DISCOVERY STREET

VICTORIA, B.C. V8T5G4

PHONE 250.590.1200

www.islanderengineering.com

CONFIRM UNDERGROUND
LOCATIONS WITH
UTILITY COMPANIES
THE LOCATION AND ELEVATION OF THE EXISTING UNDERGROUND INFRASTRUCTURE SHOWN ON THIS

DRAWING MAY NOT BE ACCURATE OR COMPLETE.

THE ACTUAL HORIZONTAL AND VERTICAL LOCATIONS

MUST BE CONFIRMED PRIOR TO THE START OF

ANY EXCAVATION.


1-800-474-6886

ONE CALL, AND HAVE EXISTING U/G SERVICES STAKED PRIOR TO ANY

REVISIONS APPROVED LEGEND **REVISIONS** DESIGN APPROVED Drain —D— Curb —C— Concrete Box ☒ Valve REVISION # 1 REVISION # 2 REVISION # 3 Approved By Date oposed Municipal Infrastructure ——— — Ditch ∕D∕ Sidewalk <u>S∕W</u> Wood Box Ø Flush Valve → Date | Signed | Approved | Date | Signed Date Signed Approved Manager of Development Manager of Development Manager of Development Manager of Development Street Lighting Pole Mount № Standard Mount ៚ Traffic Sign 👄 Silt Trap 🛮 Cap / Plug — Air Valve Development Coordinator Post Top 💠 Pedestrian Signal 🖶 Traffic Signal ß Ctrl Monument 🙆 Traverse Hub 🛧 Gas Valve 🤌 Water Meter 🖯

CITY OF VICTORIA ISLANDER 2842 FILE # MUNICIPAL 1276 GLADSTONE AVENUE DESIGN # REV. # CONCEPTUAL SITE SERVICING PLAN C01 DRAWING # Checked: JRCE Drawn: AF 1 OF 2 SHEET # Date: 2023-12-08

1276 GLADESTONE **MULTI FAMILY DEVELOPMENT**

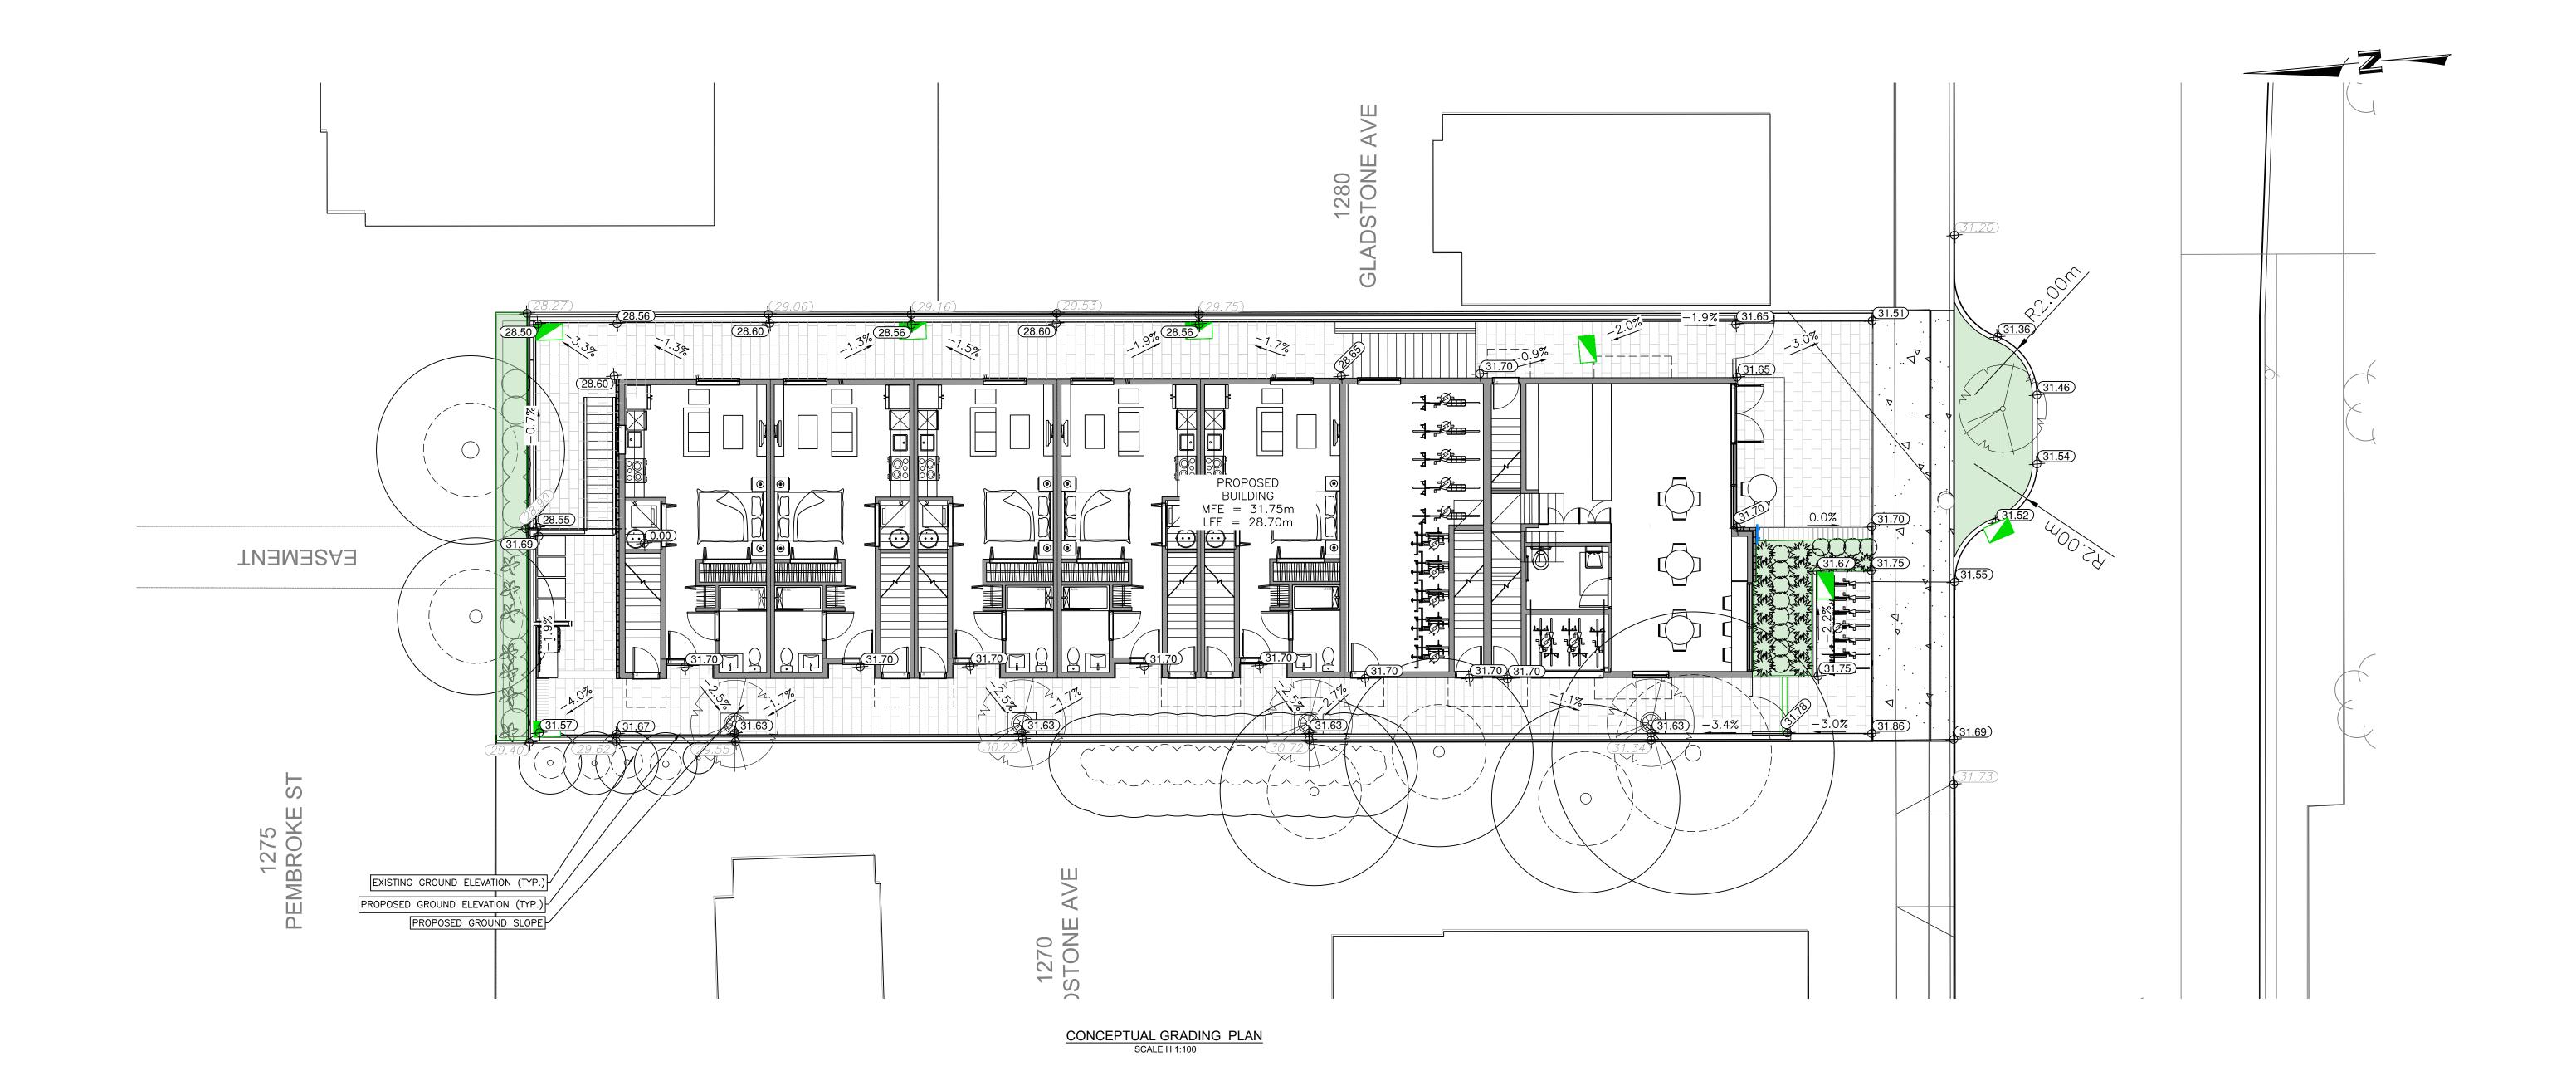



CONSTRUCTION

DECEMBER 8, 2023 SUBMITTED FOR REZONING / **DEVELOPMENT PERMIT APPLICATION**

ISLANDER ENGINEERING 623 DISCOVERY STREET VICTORIA, B.C. V8T5G4 PHONE 250.590.1200 www.islanderengineering.com

CONFIRM UNDERGROUND LOCATIONS WITH UTILITY COMPANIES

LEGEND REVISIONS APPROVED DESIGN APPROVED **REVISIONS** - Drain —D— Curb —C— Concrete Box ⊠ Valve REVISION # 1 REVISION # 3 Approved By Date REVISION # 2 — Ditch ✓D✓ Sidewalk S/W Wood Box Ø Flush Valve →X roposed Municipal Infrastructure ——— Approved Date Signed Approved Date Signed Approved Date Signed Design Engineer Manager of Development Manager of Development Manager of Development Manager of Development Street Lighting Pole Mount ₀♡ Standard Mount ♡ Traffic Sign ➡ Silt Trap 🛮 Cap / Plug → Air Valve Development Coordinator Post Top 💠 Pedestrian Signal 📼 Traffic Signal ち Ctrl Monument 🔕 Traverse Hub 🛧 Gas Valve 🤌 Water Meter 🖯 1

CITY OF VI	ISLANDER FILE #	2842	
1276 GLADSTON	MUNICIPAL DESIGN #	1	
CONCEPTUAL GRAD	REV. #	-	
B.M. : -	Elev: -	DRAWING #	C02
Design: AF Drawn: AF	Checked: JRCE	OUEET #	0 0 0
Scale: Hor: 1:200 Vertical: —	Date: 2023-12-08	SHEET #	2 OF 2

THE LOCATION AND ELEVATION OF THE EXISTING UNDERGROUND INFRASTRUCTURE SHOWN ON THIS DRAWING MAY NOT BE ACCURATE OR COMPLETE. THE ACTUAL HORIZONTAL AND VERTICAL LOCATIONS

MUST BE CONFIRMED PRIOR TO THE START OF

ANY EXCAVATION.





Address: 302-666 Cook Street, Victoria BC, V8V 3Y7

Phone: 778-584-0582 email: charper@charch.ca

web: charch.ca

Mayor and Council City of Victoria, 1 Centennial Square, Victoria, BC V8W 1P6

Letter to Mayor and Council

Re: Rezoning and Development Permit Application, 1276 Gladstone Street

Dear Mayor and Councilors,

On behalf of the applicant, Ashley and Tonny Kiptoo, residents and active members of the Fernwood community, we submit this application for a site-specific rezoning and Development Permit for a mixed-use multi-family development at 1276 Gladstone Street.

Project Summary

Situated right in the heart of Fernwood, adjacent to the Village Square, the subject site is in a "walkers paradise" with a 94% walking score, very bikeable with excellent access to transit. The proposed development is for a dynamic car-free, four-storey mixed-use building containing ground-oriented commercial space and rental housing. The proposed residential unit-mix is comprised of 5 studio units, 5 one-bedroom units, 2 two-bedroom units and 6 three-bedroom family units, with private outdoor roof top spaces. Other common residential amenity spaces include a common patio/BBQ area, three bike storage rooms and a secure residential storage room. The applicants envision a bakery or similar hospitality type retailer for the commercial space with indoor and outdoor patio seating for public use.

Project Benefits:

The project will add to Victoria's Missing Middle housing stock, which accounts for just five per cent of new home construction, with apartments, condos and detached houses making up the other 95 per cent. This project will create 16 net new housing units on the site, with 45% of the new homes being 2 & 3 bedroom, family sized housing options, and 5 of the accessible ground level units are also designed as adaptable dwellings. The added density/housing proposed on the site provides additional housing options for those wishing to remain in the City, thereby supporting the local economy and sustainability initiatives. The housing tenure will be rental in perpetuity and will hopefully add stock to the shortage of rental housing and the Cities corresponding initiatives. Additional to the community car share benefits, sidewalk and boulevard improvements listed below, the project will contribute approximately \$25,000 in additional property taxes per year.







Address: 302-666 Cook Street, Victoria BC, V8V 3Y7

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Design and development permit guidelines

The proposal adheres to the Fernwood Village Design Guidelines and Multi-Unit Residential, Commercial Guidelines. The building is designed with sensitivity to context, and builds upon without replication or mimicry, the character of Fernwood village through a contemporary application of brick and storefront glazing. Further, the proposed ground-oriented commercial space with residential use above is in character with the rest of Fernwood Square.

Details of the design addressing the Fernwood Village Design Guidelines and Multi-Unit Residential, Commercial Guidelines include but are not limited to the following:

- Highly transparent storefront and articulated ground floor with recessed entry emphasize and punctuate the commercial area.
- Use of high-quality and/or textured materials including brick, brick accents and metal canopies at street façade. The project proposes to repurpose reclaimed brick from local "unbuilding" companies on the street and rear facades, true to Fernwood's sustainable recycle culture and environmental consciousness.
- Brick banding as a form of contemporary ornamentation and detailing.
- Vertically proportioned punched residential window openings.
- Back-of-house features have been located at the lower floor level to maintain the integrity of the street frontage. Water entry and electrical room are located below the building, and adjacent to street to provide convenient access for BC Hydro and efficient tie-in to municipal services.
- Ground floor units are designed as adaptable dwelling units.
- Private rooftop patios for the family units provide the opportunity for urban farming, private family outdoor space. The rooftops are set back with simple forms and minimal detailing and articulation.
- The proposal intends to meet the City's tree Bylaws for onsite trees and provide for one on-street tree on the boulevard.
- Native landscaping complements and balances the building's material palette. Onsite pavers
 mark a transition from the public sidewalk to the property. Trees and planting along the west and
 rear side yard and a fence along the side and rear yards provide a buffer and privacy to
 neighbouring sites. A qualified arborist will be onsite to monitor any potential damage to offsite
 neighboring protected trees.

Government Policies:

The Land Use Designation of the site per the OCP is Small Urban Village. The proposed form of development is congruent with the Small Urban Village-Urban Place Guidelines which allows multi-unit residential up to 4-storeys with ground-oriented commercial use. The proposed development supports the Fernwood Neighbourhood Plans goals to "enhance Fernwood Village with additional local-servicing businesses, housing options and refreshed public spaces".







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Neighbourhood and Impact:

The proposed building presents as a three-storey building on the Gladstone Avenue frontage with ground oriented commercial space and rental housing above (and behind), which is typical of the adjacent Fernwood square and provide a harmonious and appropriate extension to Fernwood Village.

Transportation and Infrastructure:

The proposal is positioned for a car-free lifestyle due to its central location and the application seeks a variance for all required on-site vehicle parking. The proposed rental homes will be within 1 minute walking distance to Vic High School, 7 minutes to George Jay Elementary School and 15 mins to Central Middle School. The location is central to various Fernwood amenities such as neighborhood parks & green spaces, employment centers, Fernwood Village, Fernwood Community Center, the Belfry Theater, Stadacona Park, Jubilee hospital, several walk-in clinics, grocery stores and the Downtown Core. The site is within 100m of 2 Modo car share vehicles and is easily serviced by transit bus routes #10, #22, #24, #25 all within 400m.

To further support residents to live car-free, the Transportation Demand Management measures include a BC Transit EcoPass for each household valued at \$18,000, a Modo membership for each household valued at \$9,000, a cash contribution of up to \$55,000 toward the purchase of a fully electric shared vehicle and an additional contribution of \$18,000 for the installation of a dual head on-street level 2 charger on Gladstone Avenue, for a total TDM package valued at \$100,000. Additionally, the project meets the required short-term and long-term bike parking requirements, providing more than the minimum required larger cargo style bicycle parking spaces, with all bike parking spaces having easy access to a 110v plug for charging. The proposal also provides for 75% additional long term secured secondary bike parking on the lower level.

Due to the infill nature of the proposal within an established neighborhood, it is anticipated that there will be easier access to adequate public infrastructure to meet the proposal, including sewer, water, and roads, further enhancing the city's greater objectives of sustainable infill development. The proposal respects a contemplated SRW, availing a portion of the property for a road dedication as part of the rezoning which is anticipated to provide for an expanded sidewalk and improved pedestrian experience along the front lot line. A site servicing plan and Sanitary Impact Assessment prepared will be provided as part of the Rezoning/Development Permit application.

Safety and Security

CPTED is addressed by avoiding blank, windowless walls, activity generators, clear site-lines, and lighting.







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CALUC

The following revisions have been made in response to feedback received during the CALUC preliminary and pre-application meetings.

- To address concerns over building height and shade impact, the rooftop access stair closest to the rear yard has been removed and replaced with an exterior stair at L4, resulting in a stepped massing and reduced shade impact on neighbouring properties to the north.
- Hicks Yew hedges have been added to the rear yard landscape area to act as screening in front
 of the exposed concrete wall.
- To address privacy and overlook concerns, the extents of the rooftop patios have been pulled back from the western roof edge. A sightline diagram has been provided as part of the Rezoning/DP application, taken at the highest points of the neighbouring sights where overlook would be most likely. The diagram demonstrates that rooftop access stairs and guards are not visible from either neighbouring property and that there is no potential for overlook, unless a person was standing directly at the west property line on 1270 Gladstone, which is unrealistic as there is landscaping in this location.
- To address environmental concerns over management of storm water drainage, site coverage
 has been reduced from 69% to 61% and permeable pavers have been added.
- Downcast sconce lighting has been proposed to minimize light pollution to neighbouring properties.
- To address concerns of a "monolithic" appearance at the rear yard elevation, brick banding has been added to match the street-facing elevation, additional windows have been provided and the façade has been broken up with the introduction of an exterior stair.

The following items offer clarification pertaining to feedback received during the CALUC preapplication meetings.

- Although the building is four storeys tall, the street-oriented south façade is only three storeys tall
 and is in keeping with the character of the nearby Fernwood Square.
- An arborist report has been provided as part of the Rezoning/DP application to address concerns
 over impact to existing trees on the western and northern borders of the site.
- A site servicing plan and Sanitary Impact Assessment prepared by Island Engineering has been provided as part of the Rezoning/DP application.
- The frequency of waste management pickups will be adjusted based on the needs of the development to ensure that the proposed garbage area is kept tidy and well-maintained.

TRG Application Review Summary

The following revisions have been made in response to feedback received from the TRG Application Review Summary.

• To address comments about providing a more distinct roof line to the building, we have increased the depth of the parapet flashing by 1.5" and extruded it out 1.5" to make the parapet more pronounced and add a shadow line.







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- To address concern over providing windows of a scale and proportion similar to the historic
 architectural pattern, we have updated the upper windows on the front façade to double-hung
 operables, matching the predominant type of the neighbouring historic buildings.
- The uppermost soldier course band on the brick facades have been bumped out by 1" to create shadows and emphasize the three-dimensional quality of the elevations as suggested by the City.
- To address concerns over the black standing seam metal siding, the cladding on the east and
 west facades have been changed to a wood style board and batten, with variation in the spacing
 of the boards on each level to differentiate the storeys and further break up the facade.
- The shadow study has been updated to include potential impacts during the summer and winter solstice, in addition to the potential impacts during the equinox already provided.
- The outdoor patio area on Gladstone Avenue was previously included for illustrative purposes and has been removed from the drawings as requested.
- The sidewalk has been widened to the internal SRW boundary and a boulevard and street tree
 have been proposed based on collaborative feedback received from the Transportation, Parks,
 Urban Design, and Planning departments.
- Based on feedback received from the Transportation and Planning departments, the bike rooms
 on level 2 with direct access from the street have been redesigned to provide all required longterm bicycle parking, including 5 cargo-style bicycle stalls. The bike room on the lower level has
 been redesigned to provide an additional 4 long term bicycle parking stalls, representing 70%
 above the minimum requirement.

ODEEN INDICATORS	
GREEN INDICATORS	
CATEGORY	GREEN ITEMS
Rating System	BC Energy Step Code 3
Site Selection and Design	 Thermally efficient building form and orientation High performance windows Appropriately sized windows for passive heating Passive ventilation for summer months Exterior Roof Insulation Low window to wall ratio.
	Canopies to reduce solar gain in summer month
Innovation and design	Solar Panel Ready, including: Conduit to roof Additional electrical panel size and space
Building Reuse	Use of salvaged brick
Transportation	 Omission of parking will reduce Green House gas emissions. Dedicated bike parking room. Walkable and biking distance to employment centers and amenities Provision of car-share memberships and transit passes
Energy Efficiency	Energy modeling and on-site testing to meet requirements of BCBC Step Code 3







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Water	Water conservation initiatives, including:			
	 Faucets with flow rate of 8L/min or less 			
	 Showerheads with flow rate of 8L/min of less 			
	 Dual flush toilets with ultra-low flow (4.5L per flush or less) 			
Landscaping and Urban Forest	Only native and adapted vegetation			
	Drought tolerant vegetation.			

In summary, our application embodies a thoughtful and comprehensive approach to sustainable urban infill development, aligning with city policies, community aspirations, and environmental goals. We appreciate your careful consideration of this proposal.

Sincerely,

Colin Harper

2023-12-11

